DESIGN CRITERIA:

PROJECT NAME: VANGUARD MODULAR - V2464-3 BUILDING SQ. FOOTAGE: 1410 SQ. FT.

2008 NEC WITH 2006/2009 AMENDMENTS 2006 IBC WITH 2007/2009/2010 GA AMENDMENTS 2006 IMC WITH 2007/2008/2010 GA AMENDMENTS 2006 IPC WITH 2007/2008/2009/2010 GA AMENDMENTS 2006 IECC WITH 2008/2009 SUPPLEMENTS & AMENDMENTS ANSI A117.1-2003

USE GROUP: B CONSTRUCTION TYPE: IBC: V-B OCCUPANT LOAD: 11

PERMISSIBLE GAS TYPE: LP NATURAL N/A

20 PSF 50 PSF 100 PSF @ CORRIDOR 2000 LBS (130 MPH 3-SEC GUST)

SEISMIC DESIGN CATEGORY B

SPECIAL CONDITIONS AND / OR LIMITATIONS:

- 1. HANDICAP ACCESS & SIGNAGE TO BE
- 2. THE BUILDING IS TO BE LOCATED PER THE REQUIREMENTS OF TABLE 602 OF THE 2006 IBC
- 3. FIRE EXTINGUISHER(S) SHALL BE INSTALLED ON-SITE
- 4. ANY REQUIRED ALARM SYSTEM SHALL BE INSTALLED
- ANY REQUIRED FLOOR DRAIN FOR THE RESTROOM
- SHALL BE INSTALLED ON—SITE BY OTHERS. ANY REQUIRED 18" VERTICAL GRABBER SHALL BE & SUPPLIED INSTALLED ON-SITE BY OTHERS.
- ANY REQUIRED EXTERIOR EMERGENCY LIGHTING SHALL BE INSTALLED ON-SITE BY OTHERS.
- WASHING MACHINE WASTE DISCHARGE SHALL COMPLY AS AN INDIRECT DRAIN W/ A STANDPIPE AS REQUIRED PER 2006 IPC 406.3 & 802.4.

FOUNDATION NOTES:

- 1. FOUNDATION AND ANCHORING ARE SUBJECT TO ACCEPTANCE AND INSPECTION BY LOCAL AUTHORITY HAVING JURISDICTION.
- 2. TIE-DOWN ANCHORING: SEE SHEET S-2
- 3. CRAWL SPACE VENTILATION TO BE PROVIDED BY OTHERS ON-SITE PER 1203.3.1 OF THE 2006 IBC

SCOPE OF WORK

NOT INCLUDED IN THE SCOPE OF WORK

- 1 UTILITIES AND UTILITY CONNECTIONS
- POURED CONCRETE (DRIVEWAY, SIDEWALK, SLABS, FOOTINGS, ETC).
- SITE PREPARATION 4 TAX OF ANY KIND
- 5. BUILDING PERMITS.
- SITE WORK

LTR

SION FOR SITE WORK HAS BEEN INCLUDED. IT IS PRESUMED THAT THE SITE WILL PROVIDE CLEAR ACCESS FOR TRUCKS AND MODULARS.

AND ALL CONCRETE WORK AT THE SITE, TO INCLUDE POURED PIERS, FOUNDATIONS, SLABS, SIDEWALKS, DRIVÉWAYS OF WHATEVER KIND ARE THE RESPONSIBILITY OF THE OWNER.

IDENTIFICATION:

STATE DECAL AND DATA PLATE PLACED IN PANEL BOX; OR PLACE ABOVE CEILING ON HITCH END (IF NO PANEL IS ON UNIT)

DECAL: VANGUARD MODULAR [GA.1

REVISION

FRAME / CHASSIS:

OUTRIGGERS: 48" O.C CROSSMEMBERS: 48" O.C.

BEAM: 12" JR. I-BEAM (99-1/2" CENTERS)

HITCH: DETACHABLE HITCH

AXLES: QUAD W/ NEW BRAKES ON TWO AXLES

TIRES: F (12-PLY) FRAME: MEDIUM

FLOOR:

BOTTOM BOARD: ROLL, POLYETHYLENE FIBER MESH INSULATION: R-19 UNFACED JOISTS: 2x8 No. 2 SYP OR BTR. AT 16" O.C.

SIDEBAND JOISTS: DOUBLE 2x8 SYP No 2 OR EQUAL DECKING: 3/4" T&G EDGE GOLD

FLOOR COVER: 1/8" TILE #51858 - SANDRIFT WHITE

26oz. CARPET #30552 - GREYHOUND

COVE BASE: 4" VINYL BROWN

EXTERIOR WALLS:

SIDEWALL HEIGHT: 9'-6" MIN.

STUDS: 2x4 No. 2 SYP OR BTR AT 16" O.C. BOTTOM PLATE: SNGL 2x4 SYP No. 3 OR BTR TOP PLATE: DBL 2x4 SYP No. 3 OR BTR HEADERS: DOUBLE 2x4 WITH 1/2" PLYWOOD FILLER FIRE BLOCKS: 2x MIN. AT CLG LINE AS REQ'D.

INSULATION: R-15 FACED

SHEATHING: WEYERHAUSER OR EQUAL HOUSE WRAP OVER 7/16" OSB

SIDING: 3/8"x12" SMART LAP SW7063 - NEBULOUS WHITE

EXT TRIM: SMART TRIM - TOP. BOTTOM. CORNERS. WINDOWS & DOORS **SW6108 - LATTE**

SKIRTING:[15] SHEETS OF 4'x8'x7/16" OSB

INTERIOR WALLS:

WALL HEIGHT: 8'-3": EXCEPT AS NOTED ON SHEET A-2

STUDS: 2x4 SYP No. 2 OR BTR AT 16" O.C. BOTTOM PLATE: SNGL 2x4 SYP No. 3 OR BTR TOP PLATE: DBL 2x4 SYP No. 3 OR BTR HEADERS: SINGLE 2x4 FLAT

FIRE BLOCKS: 2x MIN. AT CLG LINE AS REQ'D.

COVERING: 1/2" V.C.G. HAMPTON GRAY M.R. GYP AROUND SHOWER/TUB ONLY

TRIM: STD. V.C.G.

FRP: 8' TALL - ALL WALLS IN RESTROOMS / LAUNDRY 8' TALL - AROUND SHOWER & TUB

INSULATION: R-11 UNFACED IN ALL INTERIOR WALLS

WINDOWS:

SIZE/TYPE 1:[08] 2/0 X 4/4 V.S. BRONZE/LOW E DUAL INSULATED

BRAND: H-R

MISC: [08] SETS OF 23" STEEL MINIBLINDS ALABASTER SIZE/TYPE 2:[02] 2/0 X 2/6 V.S. BRONZE/LOW E DUAL INSULATED

BRAND: H-R

MISC: [02] SETS OF 23" STEEL MINIBLINDS ALABASTER

PROJECT:

DOORS:

FXTFRIOR: [03] 36"x80" STEELCRAFT W/10x10 SAFETY PANE **EXT. DOORS PAINTED: SW7063 - NEBULOUS WHITE**

EXTERIOR HARDWARE: GRADE 2 TELL

[03] PASSAGE

[03] DEAD BOLT

[03] H.D. HYD. CLOSER

INTERIOR: [08] 36"x80" MOHAWK - SOLID CORE

[04] 36"x80" BI-FOLD W/ WOOD FRAME (WHITE)

INTERIOR HARDWARE GRADE 2 TELL

[06] PASSAGE (LEVERS)

[02] PRIVACY (LEVERS)

REDI-FRAME (BRONZE STEEL)

MISC: [08] FLOOR MTD. DOOR STOPS

ROOF:

RAFTERS: 2x8 #2 SYP. OR BTR. @ 16" O.C.

RIM MBR: SNG. 2x8 SYP #2

RIDGE BEAM: 2 LAYER - 28" HEIGHT & 60' LENGTH

CEILING: 2'x4' ACOUSTIC TILE, LAYIN @ 7'-10" A.F.F. 2'x4' VINYL COVERED TILE IN RESTROOMS ONLY

INSULATION: R-30C UNFACED

SHEATHING: (2) LAYERS OF 15# FELT OR EQUIV.

OVER 7/16" OSB

ROOFING: 20YR. FIBERGLASS SHINGLES COLOR: (3 IN 12 PITCH)

MANSARD: N/A

ELECTRICAL:

SERVICE: 120/240V SINGLE PHASE LOAD CENTER:[01] 100 AMP, INT. MOUNT LOAD CTR **MODEL: CUTLER HAMMER - BR1224B100** 01] 200 AMP. INT. MOUNT LOAD CTR.

MODEL: CUTLER HAMMER - BR2040B200 ENTRANCE: 1-1/2" @ 100A & 2" @ 200A STUB-DN WIRING: MC CABLE W/ #12 WIRE

LIGHTS: [14] 48" T-8 4 TUBE FLOURESCENT TROFFERS W/ DIFFUSED LENS

[03] PORCH LT. W/PHOTO-CELL FLUORESCENT

[03] EMERGENCY/EXIT LIGHT W/ BATTERY BACKUP

FANS: [01] 80CFM EXHAUST FAN [02] 180CFM EXHAUST FAN

RECEPTS: [26] STD. 120V DUPLEX RECEPTACLES IVORY

[05] GFI 120V DUPLEX RECEPTACLES IVORY

[02] DEDICATED 120V DUPLEX RECEPTACLES [01] DEDICATED 50A/240V RANGE RECEPTACLE

[01] DEDICATED 30A/240V DRYER RECEPTACLE [01] GFI 120V UNDER FLOOR HEAT TAPE RECEP

[01] W.P. EXT. GFCI 120V RECEPTACLE

COVER SHEET / SPECIFICATIONS

SWITCHES: SEE SHEET E-1

TITLE:

J-BOXES: [06] W/ 3/4" ENT STUBBED ABOVE CEILING

MISC: [04] SMOKE DETECTOR W/ BATTERY (D/C)

NOTE: THE GROUNDING ON-SITE IS TO BE IN ACCORDANCE WITH NEC 250-50.

PLUMBING:

WATER SUPPLY: CPVC

WASTE: PVC SCHEDULE 40 [MULTIPLE DROPS]

WATER HEATER: [01] 50 GALLON

WATER CLOSET: [02] H.CAP ELONGATED BOWL W/ TANK LAVATORY: [02] MTD. IN COUNTERTOP AT HANDICAP HT. W/

DUAL LEVER FAUCET. INSULATE HOT SUPPLY AND DRAIN TAILPIECE.

SINKS: [01] DBL. BOWL KITCHEN MTD. IN C. TOP @ H.C. HT. W/ SINGLE LEVER FAUCET. INSULATE HOT SUPPLY AND DRAIN TAILPIECE

[01] FIBERGLASS MOP SINK W/ LEGS

SHOWER: [01] HANDICAP W/ CURTAIN

[01] HANDICAP TUB/SHOWER W/ SEAT & CURTAIN

INSTALL 2-SETS OF S.S. GRAB BARS T.P. HOLDERS, [02] FRAMED MIRRORS

WASHER SUPPLY BOX

DRYER VENT

โด1โ 3/4 HORSE POWER GARBAGE DISPOSAL

FLOOR DRAIN W/ TRAP PRIMER

[01] ICE MAKER BOX

[03] 12x12 S.S. ACCESS PANELS

DRINKING FOUNTAIN SHALL BE AVAILABLE ON-SITE OR BE INSTALLED BY OTHER AS REQUIRED BY LOCAL OFFICIALS.

ALL FIXTURE MOUNTING HEIGHTS PER ANSI A-117.1

HVAC:

3-TON WALL MTD. WITH 10 KW HEAT STRIP W/ 60A EXTERIOR DISCONNECT

BARD MODEL #: W36A10 - BEIGE

THERMOSTAT: [02] PROGRAMMABLE DUCTS: FIBERGLASS - 1-1/2" (R-6)

[01] 6" SCOOPS & [05] 8" SCOOPS W/ COLLAR SUPPLY: 24"x24" ADJUSTABLE DAMPERS

RETURN-AIR: ABOVE PLENUM WALL W/ DUCTED RETURN

FRESH AIR VENTILATION IS PROVIDED THRU MANUAL AIR DAMPER IN THE HVAC SYSTEM.

FURNITURE OR MISC:

COUNTER TOP: 18 L.F. POST FORMED FROSTY WHITE

19 L.F. FORMICA LAMINATE WHITE

BASE CABINET: [01] B12, [02] B24, [01] BBC39,

[03] DWEP3 UPPER CABINET:[03] W2430, [01] W3015, [02] W3030

[02] W3630, [01] WBC3630D, [02] WEP30 [01] WBC3930D, [01] W1830, [01] W2730

MISC: [02] 2-DRAWER 25" METAL FILE CABINET 15 L.F. OF WIRE SHELVING

DRAWING INDEX:

COVER SHEET / SPECIF ENERGY DESIGN INFORM FLOOR PLAN CABINET ELEVATION CROSS—SECTION EXTERIOR ELEVATION HVAC LAYOUT ELECTRICAL

CUSTOMER APPROVAL **APPROVED** APPROVED EXCEPT AS NOTED3

A-1

A-2.7

SEE ATTACHED

832 EAST WALNUT

PANEL BOX & ELEC. PLUMBING - DRAIN PLUMBING - WATER

HEAT LOSS CALCULATIONS

RIDGE BEAM

APPROVAL BY WATE.

THIS PRINT MUST BE SIGNED, DATED AND RETURNED TO AMTEX CORP. BLOCKING & TIEDOWN PLAN

> LAZENBY & ASSOCIATES, INC. 2000 NORTH 7th STREET

WEST MONROE, LA 71294 #(318) 387-2710

GARLAND, TX 75040 FAX: (972) 276-5105 (972) 276-7626

DRAWN BY: M.L.S. **VANGUARD MODULAR** DATE: SCALE: DWG. NO. 3/16/09 N.T.S.


DATE


BY


V2464-3


SHEET A-1

Èmail: engineering@amtexcorp.com

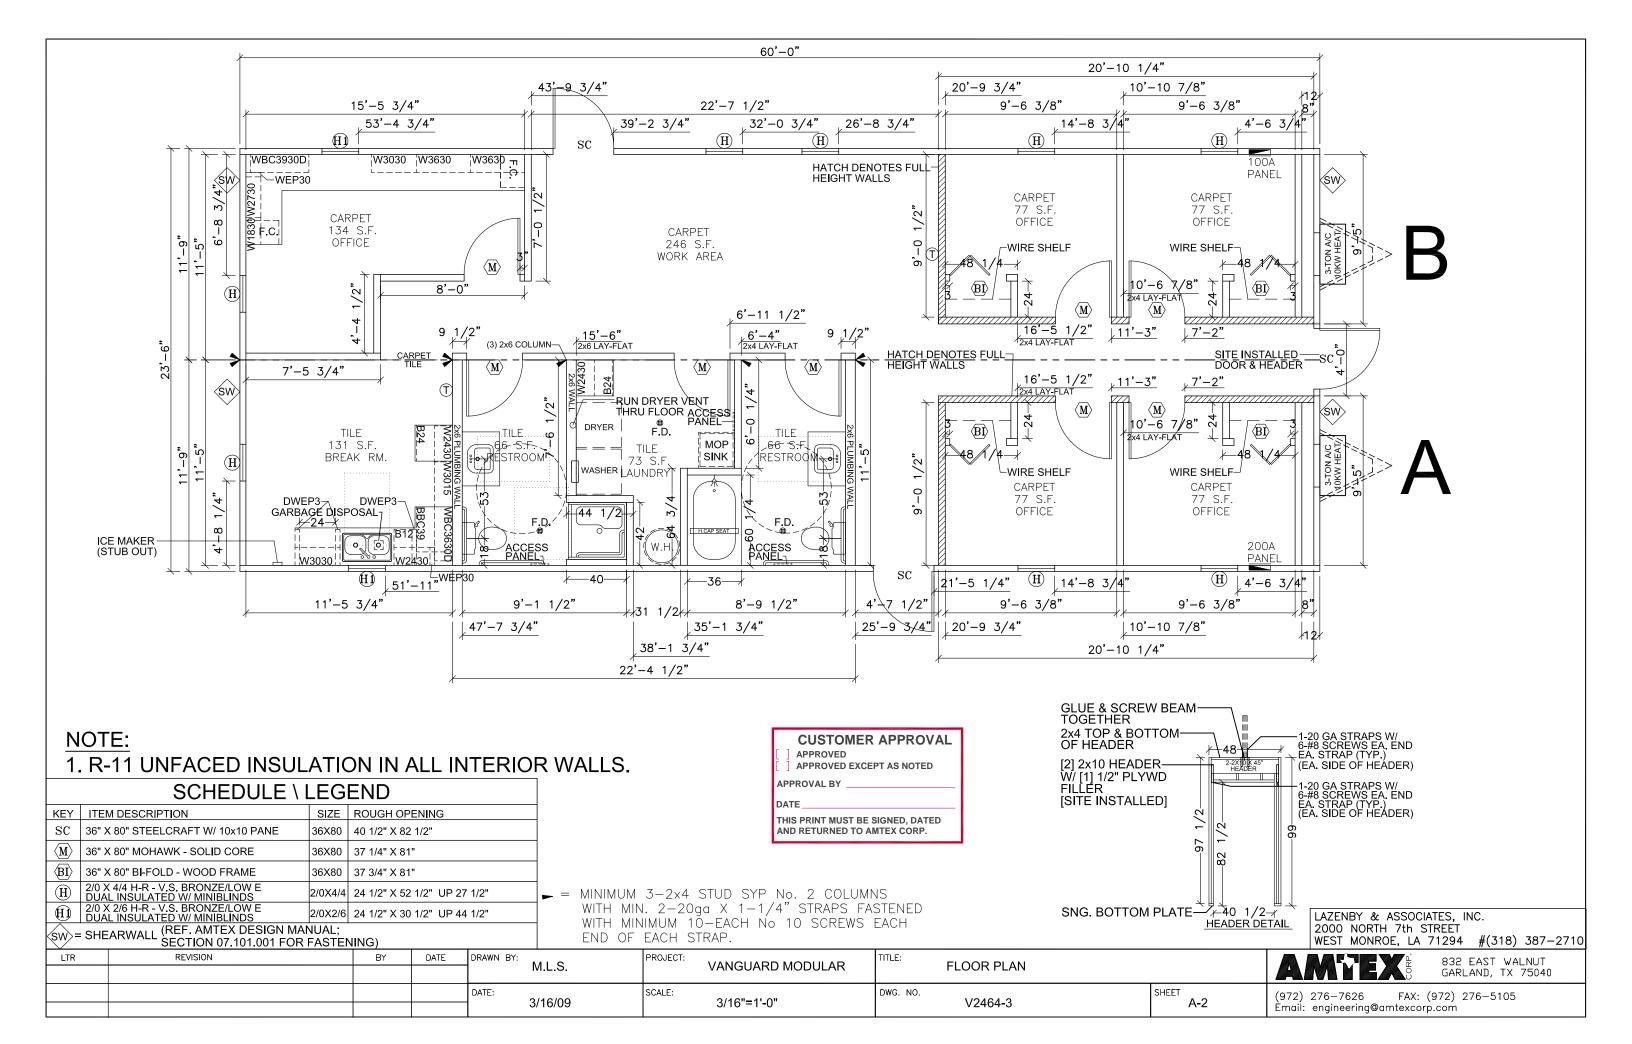


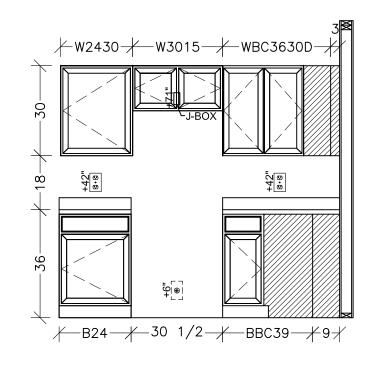


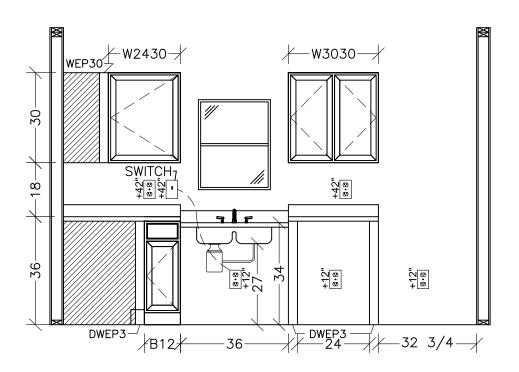


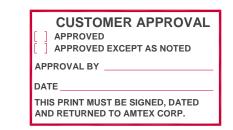

LTR	REVISION	BY	DATE	DRAWN BY:	PROJECT: VANCUARD MODULAR	CABINET ELEVATION		832 EAST WALNUT	
				WI.L.S.	VANGUARD MODULAR	CABINET ELEVATION		GARLAND, TX 75040	
				DATE: 2/16/00	SCALE: 2/9"-1! 0"		SHEET	(972) 276-7626 FAX: (972) 276-5105	
				3/16/09	3/8"=1'-0"	V2464-3	A-2.1	Émail: engineering@amtexcorp.com	

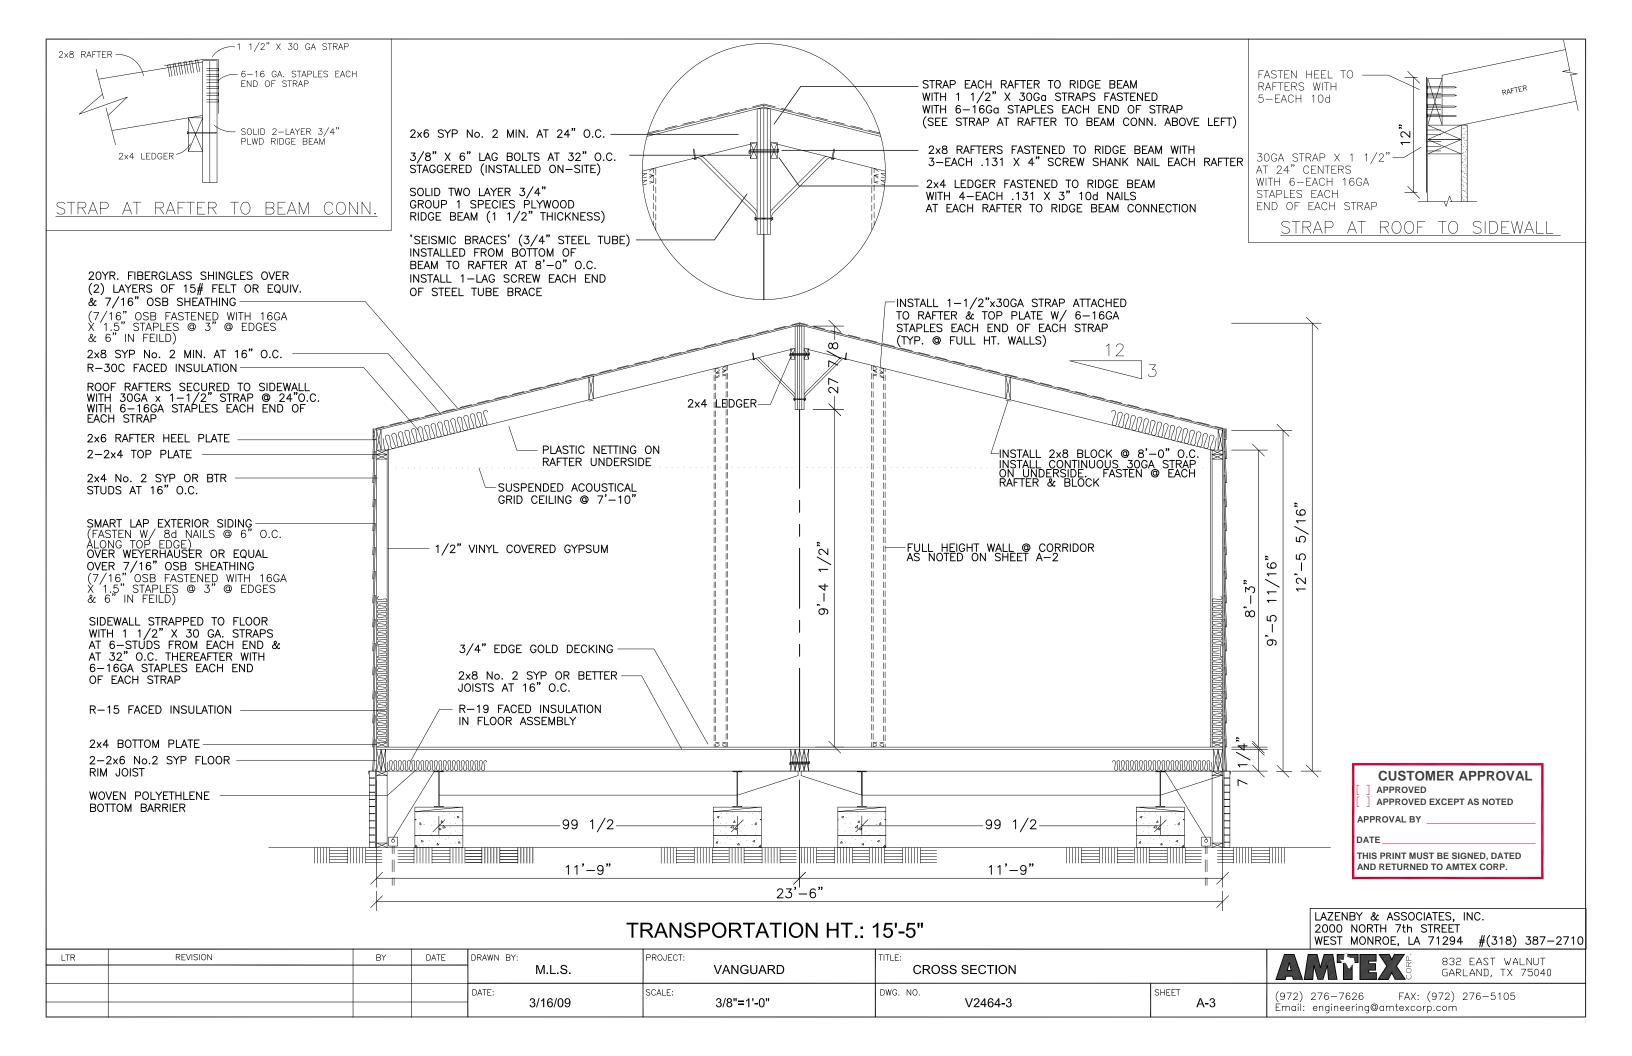

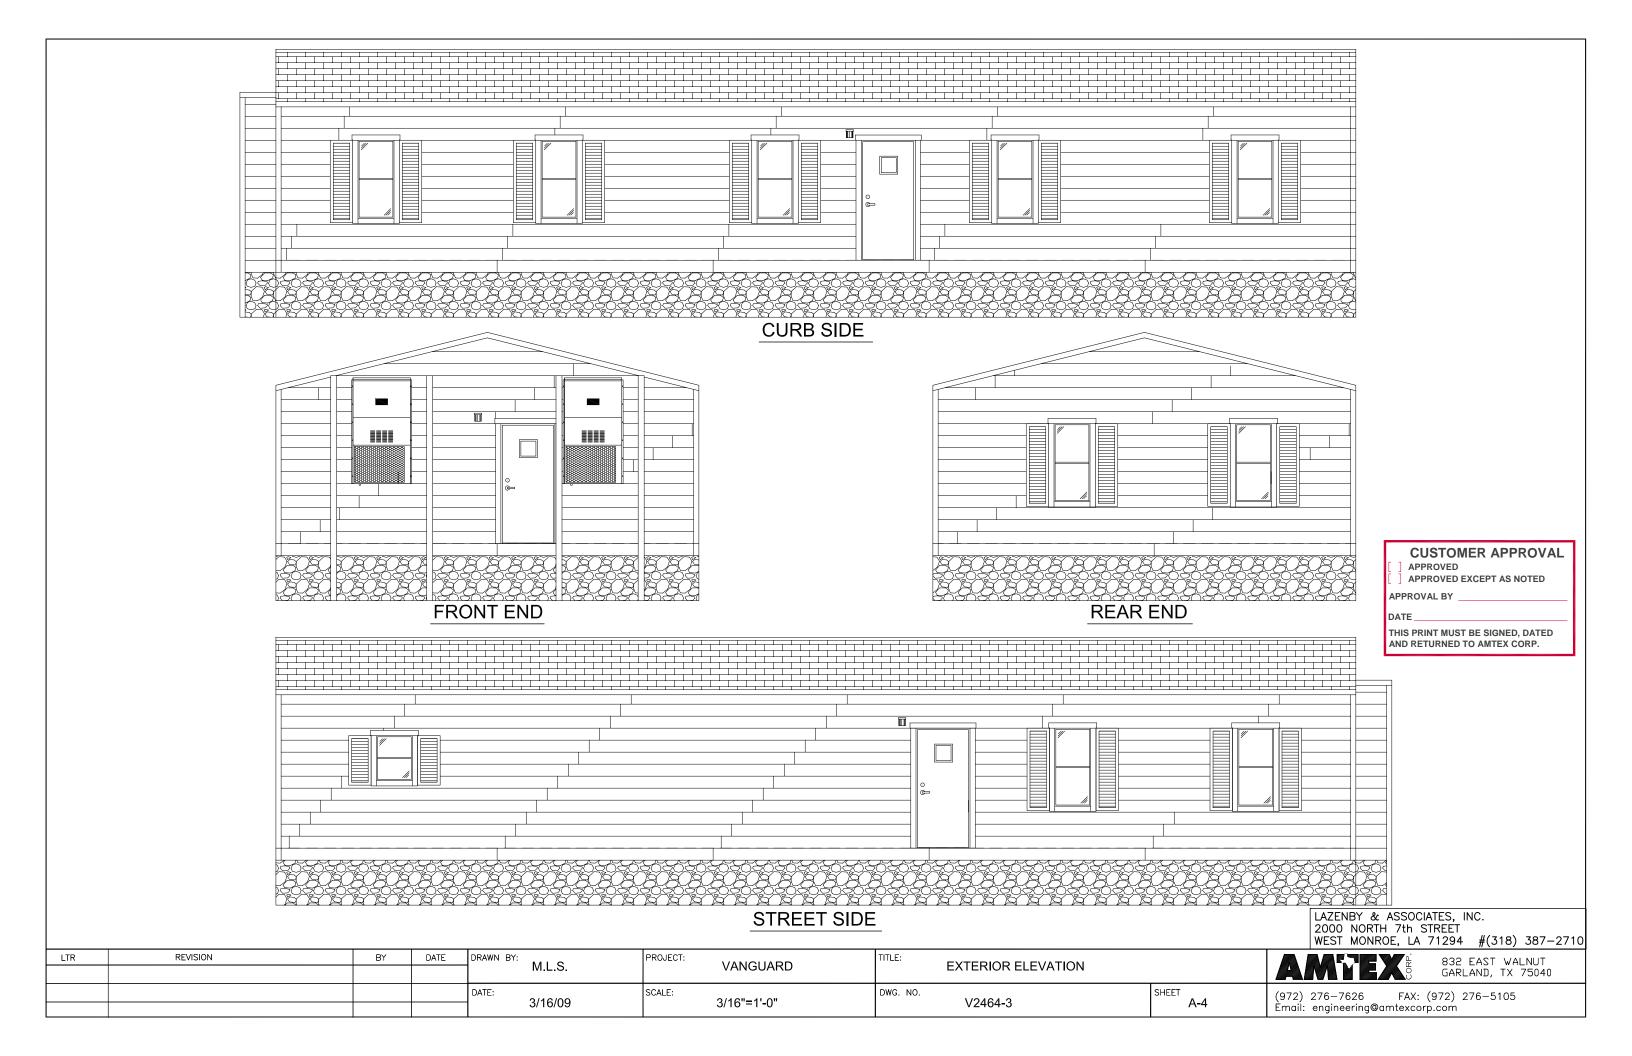

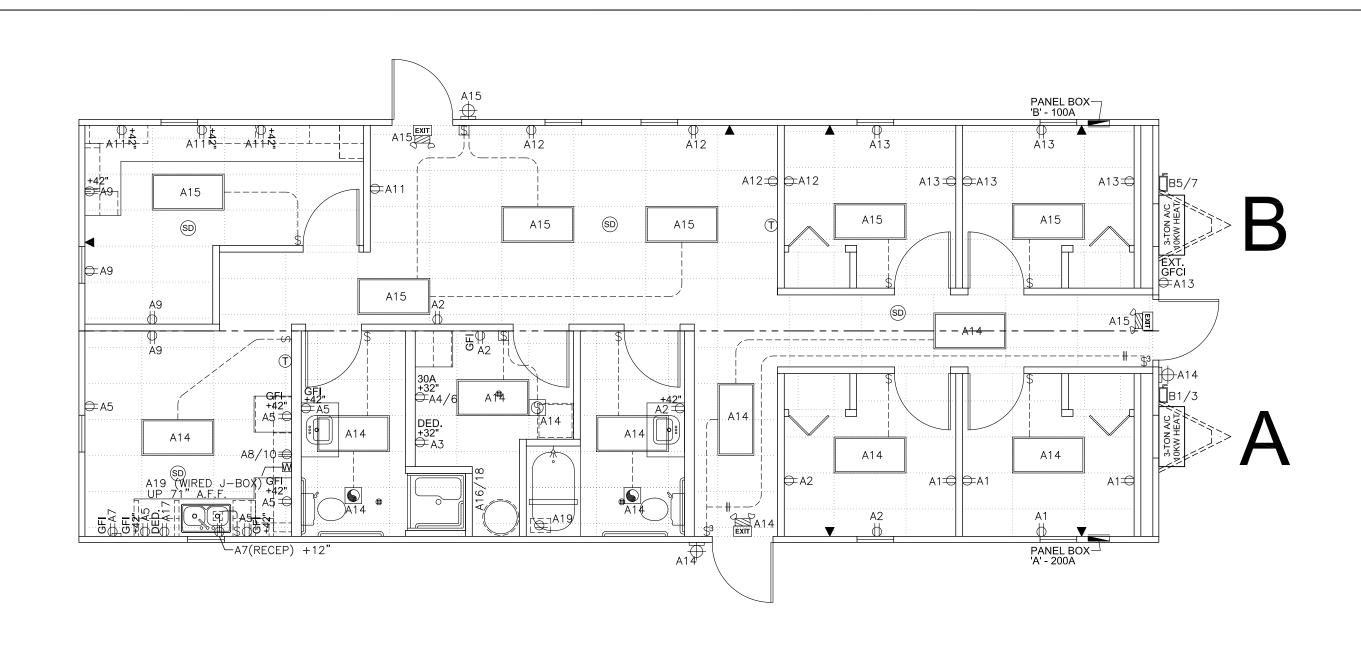

SYMBOL LEGEND

2'x4' T-8 4 TUBE TROFFER W/ DIFFUSED LENS 80CFM EXHAUST FAN ONLY

180CFM EXHAUST FAN ONLY

EXT. PORCH LIGHT W/ PHOTO CELL

PHONE / DATA JACK STUB-IN LCTN

120v DOUBLE TOGGLE SWITCH

120V GFI RECEP MTD. UNDER FLOOR FOR ON-SITE HEAT TAPE

120V DUPLEX RECEPTACLE

200 AMP LOAD CENTER EXT. DISCONNECT

THERMOSTAT LOCATION (+48")

SURFACE MTD. SMOKE DETECTOR (D/C)

EMER./EXIT W/ BATT. BACKUP

CUSTOMER APPROVAL APPROVED APPROVED EXCEPT AS NOTED APPROVAL BY THIS PRINT MUST BE SIGNED, DATED AND RETURNED TO AMTEX CORP.

LAZENBY & ASSOCIATES, INC. 2000 NORTH 7th STREET WEST MONROE, LA 71294 #(318) 387-2710

\$ 120v SINGLE TOGGLE SWITCH DRAWN BY: LTR BY DATE PROJECT: TITLE: 832 EAST WALNUT GARLAND, TX 75040 VANGUARD MODULAR M.L.S. **ELECTRICAL** DWG. NO. (972) 276-7626 FAX: (972) 276-5105 3/16/09 3/16"=1'-0" V2464-3 Èmail: engineering@amtexcorp.com

PANEL BOX 'A' LOAD CALCULATION

14 FOUR TUBE FLR. LIGHT AT 122 WATTS EACH X 125% 2135 WATTS 03 FLUORESCENT PORCH LIGHT AT 13 WATTS EACH X 125% 49 WATTS 25 120v RECEPTACLES AT 180 WATTS EACH 4500 WATTS 07 GFI 120v RECEPTACLES AT 180 WATTS EACH **1260 WATTS** 01 W.P. EXT. GFCI 120v RECEP. AT 180 WATTS **180 WATTS** 01 GFI120v HEAT TAPE RECEP. AT 1400 WATTS 1400 WATTS 01 STD. 120v RECEP. AT 840 WATTS (FRIDGE) **840 WATTS** 01 DEDICATED 240v RECEP. AT 10600 WATTS (RANGE) 10600 WATTS 01 DEDICATED 240v RECEP. AT 5600 WATTS (DRYER) 5600 WATTS 01 DEDICATED 120v RECEP. AT 1200 WATTS (WASHER) 1200 WATTS 01 STD. 120v RECEP. AT 504 WATTS (DISPOSAL) 504 WATTS 01 DEDICATED 120v RECEP. AT 1450 WATTS (DISH WSHR) 1450 WATTS 01 WIRED J-BOX AT 850 WATTS (VENT HOOD) **850 WATTS** 03 EMER/EXIT SIGN W/ BATT. BACKUP AT 18 WATTS X 125% 68 WATTS 01 80CFM EXHAUST FAN AT 156 WATTS **156 WATTS 408 WATTS** 02 180CFM EXHAUST FAN AT 204 WATTS 01 50-GALLON WATER HEATER AT 4500 WATTS 4500 WATTS 35700 WATTS

TOTAL LOADS: 35700 WATTS÷240 = 149 AMPS

PANEL BOX 'B' LOAD CALCULATION
02 3-TON AC W/10KW (HEATING CONTROLS)

TOTAL LOADS: 21248 WATTS÷240 = 89 AMPS 21248 WATTS 21248 WATTS

CUSTOMER APPROVAL

[] APPROVED

[] APPROVED EXCEPT AS NOTED

APPROVAL BY

DATE

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AND RETURNED TO AMTEX CORP.

PANEL BOX 'A' 200 AMP MAIN BREAKER


WIRE	CIRCUIT	AMP			AMP	CIRCUIT	WIRE	
#12	RECEPTACLES	20	1	2	20	RECEPTACLES	#12	
#12	DEDICATED RECEP.	20	3	4	30		#4.0	
#12	RECEPTACLES	20	5	6	2P	DRYER RECEP.	#10	
#12	DEDICATED RECEP.	20	7	8	50	DANAS DEAFR	#0./Z	
#12	RECEPTACLES	20	9	10	2P	RANGE RECEP.	#8/3	
#12	RECEPTACLES	20	11	12	20	RECEPTACLES	#12	
#12	RECEPTACLES	20	13	14	20	LIGHTS	#12	
#12	LIGHTS	20	15	16	30	WATER HEATER	#40	
#12	DISHWASHER	20	17	18	2P	WATER HEATER	#10	
#12	HEAT TAPE RECEP.	20	19	20	_	OPEN		

GROUND BAR H+ NEUTRAL

PANEL BOX 'B' 100 AMP

WIRE	CIRCUIT	AMF)		AMP	CIRCUIT	WIRE				
		60	1	2	60		"0				
#6	HVAC UNIT	2P	3	4	2P	HVAC UNIT	#6				
_	OPEN	_	5	6	_	OPEN	_				
_	OPEN	_	7	8	_	OPEN	_				
	OPEN	_	9	10	_	OPEN	_				
_	OPEN	_	11	12	_	OPEN	_				
	GROUND BAR H+ NEUTRAL										

LTR	REVISION	BY	DATE	DRAWN BY:	PROJECT: VANGUARD MODULAR	TITLE:		832 EAST WALNUT
				M.L.S.	VANGUARD MODULAR	PANEL BOX & ELECTRICAL CALCS.		GARLAND, TX 75040
				DATE:	N. T. O.	DWG. NO.	SHEET (9	972) 276-7626
				3/16/09	N.I.S.	V2464-3	E-1.1	mail: engineering@amtexcorp.com

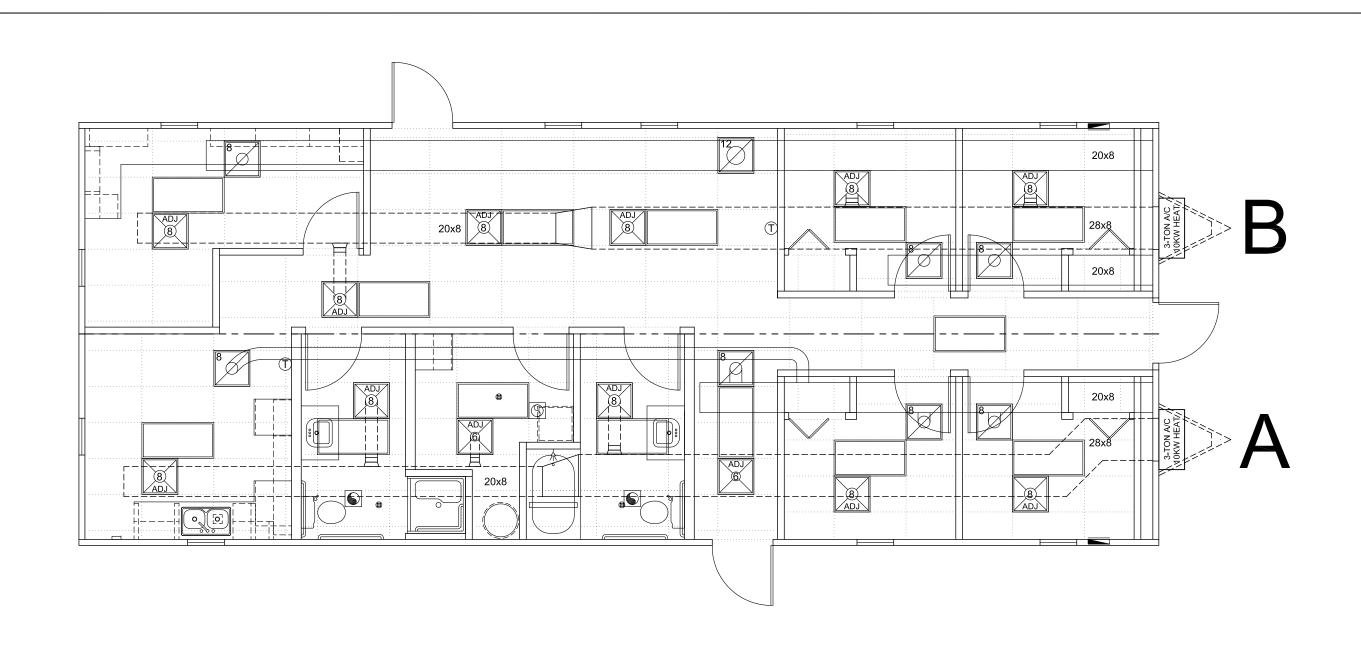

SYMBOL LEGEND



24" X 24" DIFFUSER ADJUSTABLE



JUMP DUCT

 \Box

SCOOP W/ COLLAR


CUSTOMER APPROVAL


APPROVED


APPROVED EXCEPT AS NOTED APPROVAL BY

THIS PRINT MUST BE SIGNED, DATED AND RETURNED TO AMTEX CORP.

LTR	REVISION	BY	DATE	DRAWN BY:	PROJECT: VANGUARD MODULAR	TITLE:		832 EAST WALNUT
				IVI.L.S.	VANGUARD MODULAR	CEILING & HVAC LAYOUT		GARLAND, TX 75040
				DATE:	SCALE: 2/46"=41 0"	DWG. NO.	SHEET	(972) 276-7626 FAX: (972) 276-5105
				3/16/09	3/16"=1'-0"	V2464-3	M-1	Émail: engineering@amtexcorp.com

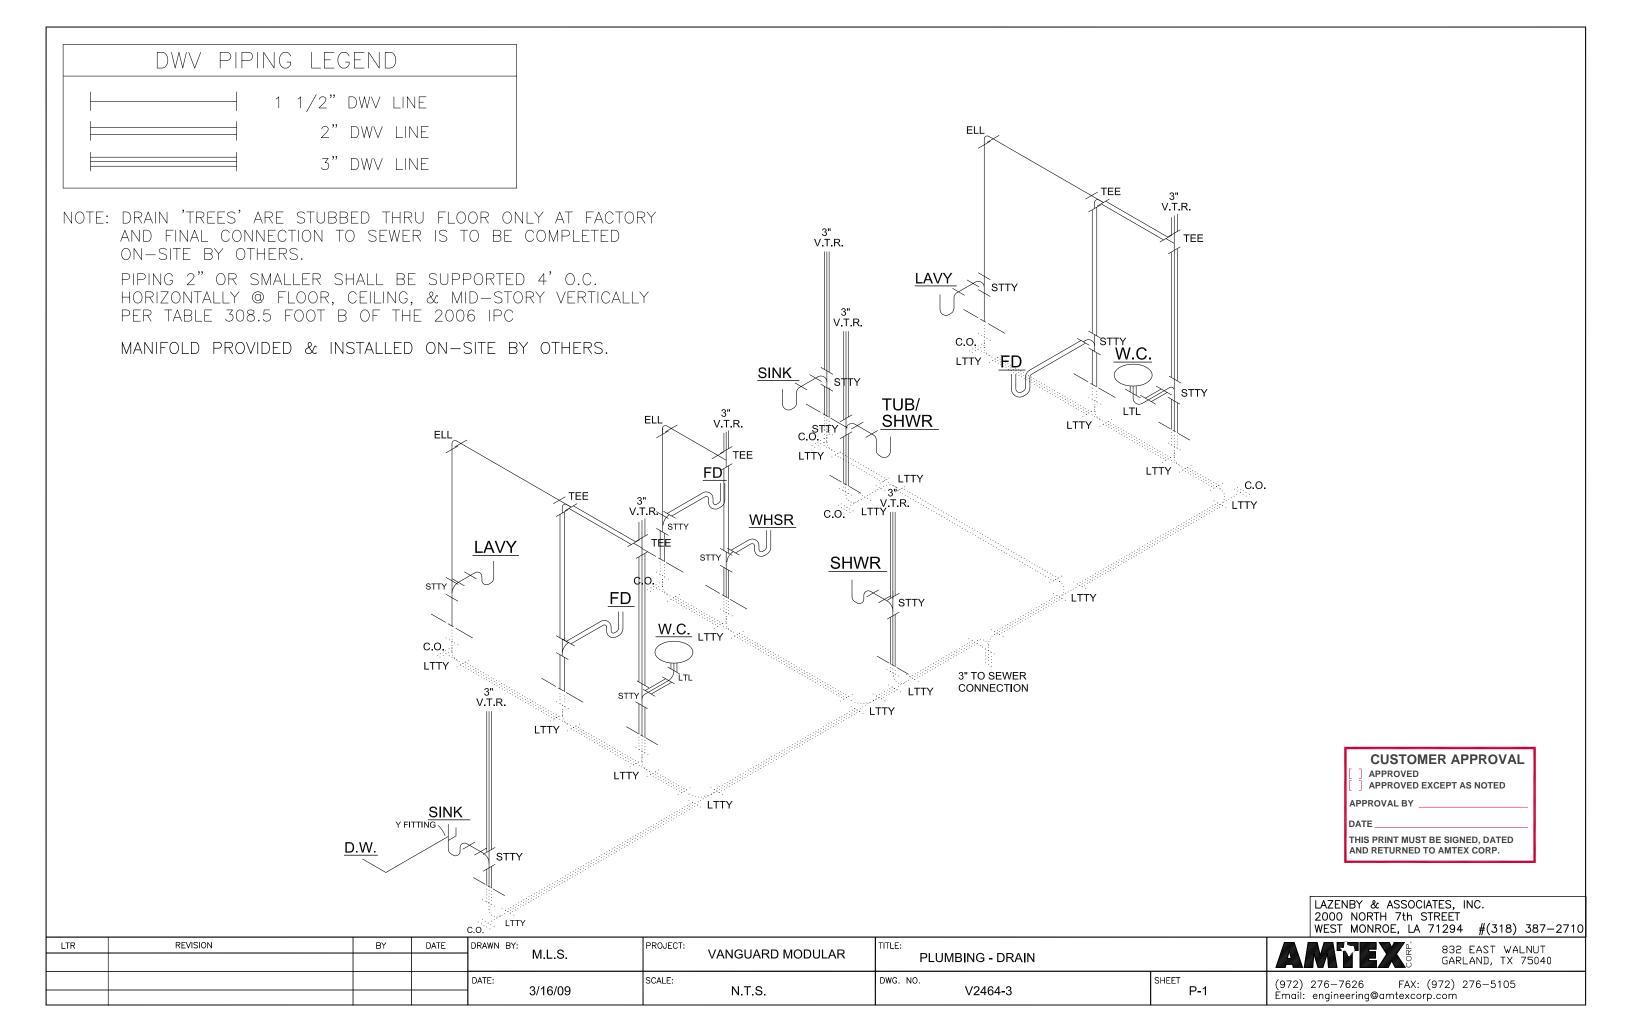

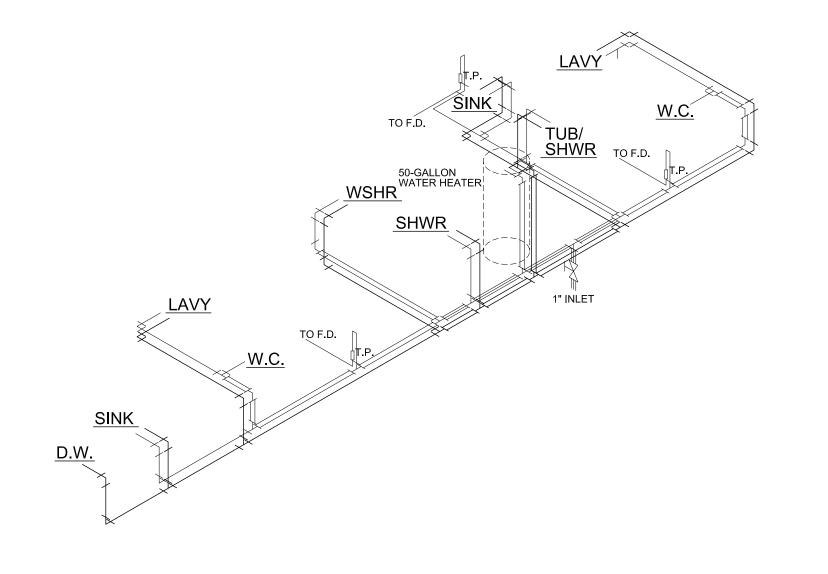


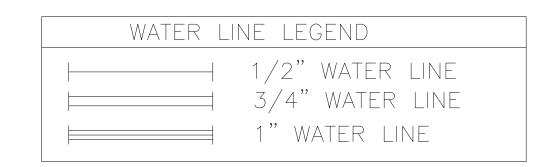

1. PER SECTION 504.5 OF THE 2006 IPC. WATER HEATERS SHALL HAVE A TEMP/PRESSURE RELIEF VALVE INSTALLED.


NOTES:

- 2. PER SECTION 504.7.1 OF THE 2006 IPC. THE DRIP PAN SHALL BE DRAINED BY AN INDIRECT WASTE PIPE HAVING A MINIMUM DIAMETER OF 3/4".
- 3. PER SECTION 504.7.2 OF THE 2006 IPC. THE DRIP PAN DRAIN SHALL EXTEND FULL—SIZE AND TERMINATE OVER A SUITABLY LOCATED INDIRECT WASTE RECEPTOR OR FLOOR DRAIN OR EXTEND TO THE EXTERIOR OF THE BUILDING AND TERMINATE NOT LESS THAN 6 INCHES AND NOT MORE THAN 24 INCHES ABOVE THE ADJACENT GROUND SURFACE.
- 4. PER SECTION 606.2 OF THE 2006 IPC. A SHUT-OFF VALVE SHALL BE INSTALLED AT EACH FIXTURE & WATER HEATER.
- 5. PIPING 1" OR SMALLER SHALL BE SUPPORTED 3' HORIZONTALLY @ FLOOR, CEILING, & MID—STORY VERTICALLY PER TABLE 308.5 FOOTNOTE B OF THE 2006 IPC.

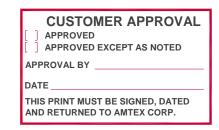


LTR	REVISION	BY DA	re dr	RAWN BY:	PROJECT:	TITLE:		832 EAST WALNUT
				M.L.S.	VANGUARD MODULAR	PLUMBING - WATER		GARLAND, TX 75040
			DA	ATE:	SCALE:	DWG. NO.	SHEET	(972) 276-7626 FAX: (972) 276-5105
				3/16/09	N.1.5.	V2464-3	P-2	Èmail: engineering@amtexcorp.com

LAYER ONE

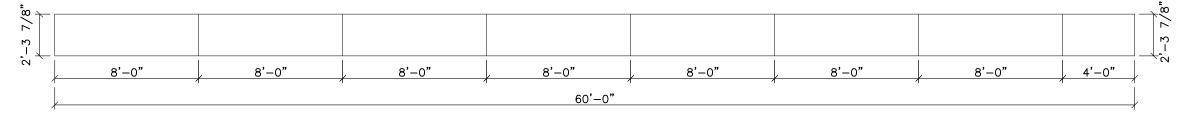

LAYER TWO

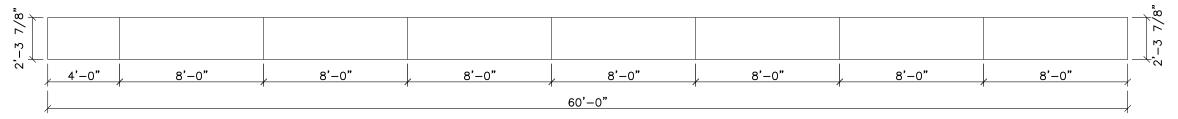


RIDGE BEAM NOTES:

- 1. RIDGE BEAM CONSTRUCTION IS THE SAME FOR BOTH SIDES OF UNIT (MIRRORED).
- 2. RIDGE BEAM IS CONSTRUCTED WITH 3/4" 5-PLY, 5-LAYER GROUP 1 SPECIES PLYWOOD.
- 3. RIDGE BEAM CONSTRUCTION SHALL BE IN ACCORDANCE WITH APA PLYWOOD DESIGN SPECIFICATION, SUPPLEMENT 5.

CUSTOMER APPROVAL								
APPROVED								
APPROVED EXCEPT AS NOTED								
APPROVAL BY								
DATE								

THIS PRINT MUST BE SIGNED, DATED AND RETURNED TO AMTEX CORP.

LTR REVISION	BY DATE	DRAWN BY: M.L.S.	PROJECT: VANGUARD MODULAR	TITLE:	832 EAST WALNUT
		Wi.E.G.	V/WVCO/WCD WCDCE/WC	RIDGE BEAM	GARLAND, TX 75040
		DATE: 3/16/09	SCALE: 3/16"=1'-0"	DWG. NO. SHEET	(972) 276-7626 FAX: (972) 276-5105
		3/16/09	3/10 -1-0	V2464-3 S-1	Émail: engineering@amtexcorp.com

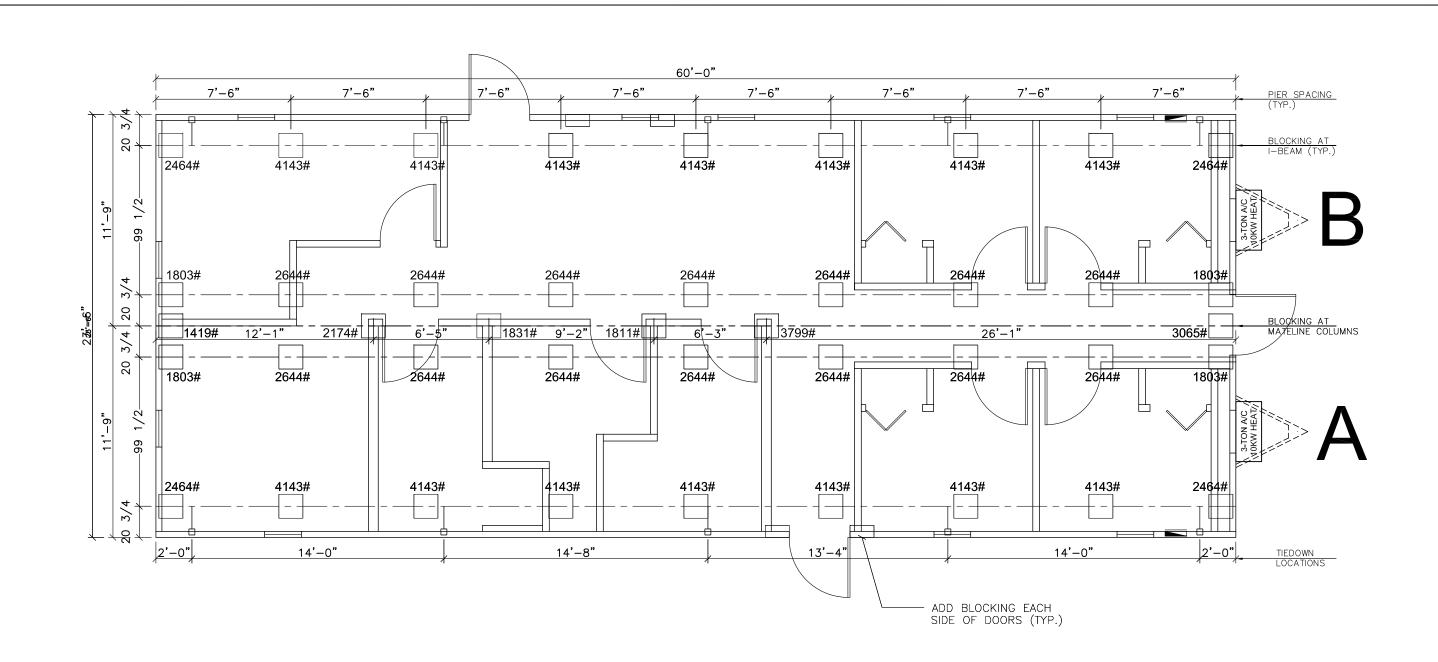

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NOTES:

- 1. SOIL CAPACITY IS ASSUMED TO BE 2500 PSF (FIELD VERIFY BY OTHERS).
- 2. PIER SPACING BASED ON ASSUMED PAD SIZE OF 16" X 16".
- 3. BLOCKS ADDED EACH SIDE OF EXT. DOORS (TYP.)

LTR	REVISION	BY	DATE	DRAWN BY: M.L.S.	PROJECT: VANGUARD MODULAR	BLOCKING / TIE DOWN		832 EAST WALNUT GARLAND, TX 75040
				DATE: 3/16/09	SCALE: 3/16"=1'-0"	DWG. NO. V2464-3	SHEET S-2	(972) 276-7626 FAX: (972) 276-5105 Email: engineering@amtexcorp.com