

ITEM	QTY	DESCRIPTION	UNIT WEIGHT	QTY WEIGHT	MATERIAL	REMARKS
1	2	PL3/8" x 5" x 20 1/2"	9.43	18.85	ASTM A514	Fy=100ksi, Fu=110ksi
2	2	PL3/8" x 5" x 11 9/16"	4.54	9.08	ASTM A514	Fy=100ksi, Fu=110ksi
3	2	PL3/8" x 5" x 11 7/16"	4.47	8.93	ASTM A514	Fy=100ksi, Fu=110ksi
4	2	PL3/8" x 5" x 117 1/2"	59.53	119.06	ASTM A514	Fy=100ksi, Fu=110ksi
5	16	PL3/8" x 15" x 22 1/2"	22.77	364.37	ASTM A514	Fy=100ksi, Fu=110ksi
6	2	PL1/2" x 28" x 90"	287.72	575.44	ASTM A514	Fy=100ksi, Fu=110ksi
7	5	PL1/2" x 16" x 28"	61.19	305.95	ASTM A514	Fy=100ksi, Fu=110ksi
8	4	PL1/2" x 4" x 5"	2.84	11.34	ASTM A514	Fy=100ksi, Fu=110ksi
9	1	PL5/8" x 11" x 237"	462.09	462.09	ASTM A514	Fy=100ksi, Fu=110ksi
10	1	PL1/2" x 90" x 179 3/8" (APPROX, FLAT)	2267.69	2267.69	ASTM A514	Fy=100ksi, Fu=110ksi
11	1	PL1/2" x 90" x 179 3/8" (APPROX. FLAT)	2267.69	2267.69	ASTM A514	Fy=100ksi, Fu=110ksi
12	8	PL3/4" x 15" x 22 1/2"	45.55	364.37	ASTM A514	Fy=100ksi, Fu=110ksi
13	4	PL1/2" x 4" x 17"	9.57	38.29	ASTM A514	Fy=100ksi, Fu=110ksi
14	1	PL3/4" x 6" x 28 1/2"	36.16	36.16	ASTM A514	Fy=100ksi, Fu=110ksi
15	2	PL1/2" x 4" x 57 3/4"	32.61	65.23	ASTM A514	Fy=100ksi, Fu=110ksi
16	2	PL3/4" x 44" x 90"	713,23	1426.46	ASTM A514	Fy=100ksi, Fu=110ksi
17	1	PL3/4" x 4" x 28 1/2"	24.25	24,25	ASTM A514	Fy=100ksi, Fu=110ksi
18	2	PL3/4" x 37 5/8" x 92 1/2"	562.57	1125.14	ASTM A514	Fy=100ksi, Fu=110ksi
19	6	PL3/4" x 34" x 37 5/8"	130.40	782.39	ASTM A514	Fy=100ksi, Fu=110ksi
20	1	PL3/4" x 6" x 33 7/8"	43.02	43.02	ASTM A514	Fy=100ksi, Fu=110ksi
21	2	PL1/2" x 4" x 57 3/4"	32.61	65.23	ASTM A514	Fy=100ksi, Fu=110ksi
22	1	PL3/4" x 4" x 33 7/8"	28.82	28.82	ASTM A514	Fy=100ksi, Fu=110ksi
23	2	PL1" x 5 1/4" x 6"	7,52	15.04	ASTM A514	Fy=100ksi, Fu=110ksi
24	4	PL1" x 3" x 26"	20.86	83.45	ASTM A514	Fy=100ksi, Fu=110ksi
25	2	PL1" x 36" x 75 1/2"	637.40	1274.80	ASTM A514	Fy=100ksi, Fu=110ksi
26	4	PL1" x 8 1/2" x 22"	38.89	155.57	ASTM A514	Fy=100ksi, Fu=110ksi
27	8	PL1" x 2 7/8" x 7 1/2"	8.73	69.84	ASTM A514	Fy=100ksi, Fu=110ksi
28	2	PL1 1/2" x 37 5/8" x 92 1/2"	1125.14	2250.28	ASTM A514	Fy=100ksi, Fu=110ksi
29	1	PIPE Ø4" NOM., SCH. 80 (Ø4.5" x 0.337" WALL) x 34" LONG	42.50	42.50	ASTM A53 GR.B	Fy=35ksi, Fu=60ksi
30	1	PIPE Ø8" NOM., SCH. 80 (Ø8.625" x 0.5" WALL) x 34" LONG	123.06	123.06	ASTM A53 GR.B	Fy=35ksi, Fu=60ksi
31	1	PL2" x 36" x 228"	4651.18	4651.18	ASTM A514	Fy=100ksi, Fu=110ksi
32	2	PL1 1/2" x 34" x 37 5/8"	260,80	521,59	ASTM A514	Fy=100ksi, Fu=110ksi
33	1	PL2" x 4" x 241 3/4"	537.71	537.71	ASTM A514	Fy=100ksi, Fu=110ksi
34	1	PL2" x 36" x 240"	4900.59	4900.59	ASTM A514	Fy=100ksi, Fu=110ksi
35	4	PIPE Ø2" NOM., SCH. 40 (Ø2.375" x 0.154" WALL) x 8 1/2" LONG	2.59	10.36	ASTM A53 GR.B	Fy=35ksi, Fu=60ksi
36	4	C 3x4.1 x 8 1/2" LONG	3.18	12.73	ASTM A36	Fy=36ksi, Fu=58ksi
37	1	PIPE Ø8" NOM., SCH. 80 (Ø8.625" x 0.5" WALL) x 32" LONG	115.82	115.82	ASTM A53 GR.B	Fy=35ksi, Fu=60ksi
38	1	PIPE Ø4" NOM., SCH. 80 (Ø4.5" x 0.337" WALL) x 32" LONG	40.00	40.00	ASTM A53 GR.B	Fy=35ksi, Fu=60ksi
50	-	. 3.2.5. 113.11, 3011, 30 (8.15 × 0.15) 117.11, 32 E011d	10100	10100		. , colon, la colon

BILL OF MATERIALS

- 1. THIS DRAWING REPRESENTS THE ORIGINAL AS FABRICATED STATE OF SME20-1 AND SME20-2 GIRDERS.
- QUANTITIES SHOWN IN BILL OF MATERIALS ARE FOR ONE WELDMENT. ACTUAL QUANTITIES SHALL BE MULTIPLIED BY THE NUMBER REQUIRED.
- 3. PLATE EDGE PREP DETAILS FOR WELDING & FIT-UP ARE PRELIMINARY OR HAVE NOT BEEN SHOWN. FABRICATOR IS RESPONSIBLE FOR FINAL EDGE PREP DETAILS AND ASSOCIATED PLATE DIMENSIONS FOR CHOSEN WELD METHOD TO MEET THE INDICATED WELDING AND FIT-UP REQUIREMENTS.
- 4. 110 ksi MINIMUM TENSILE STRENGTH ELECTRODES U.N.O.

LINEAR FRACTIONAL: ± 1/16"

HOLES FRACTIONAL: +1/32" - 0"

\*DO NOT SCALE OFF OF DRAWING

(25)
(33)
34)
TYP. (26)
TYP. (27)
(12) TYP.
38
25 1 TYP.
(30) (4) TYP.
(31)
19 (24) TYP. REAK ISOMETRIC VIEW NOTE: WEB PLATE (ITEM 10) REMOVED FOR CLARITY
(18) (5) TYP.

## **20'-0" BOX GIRDER**

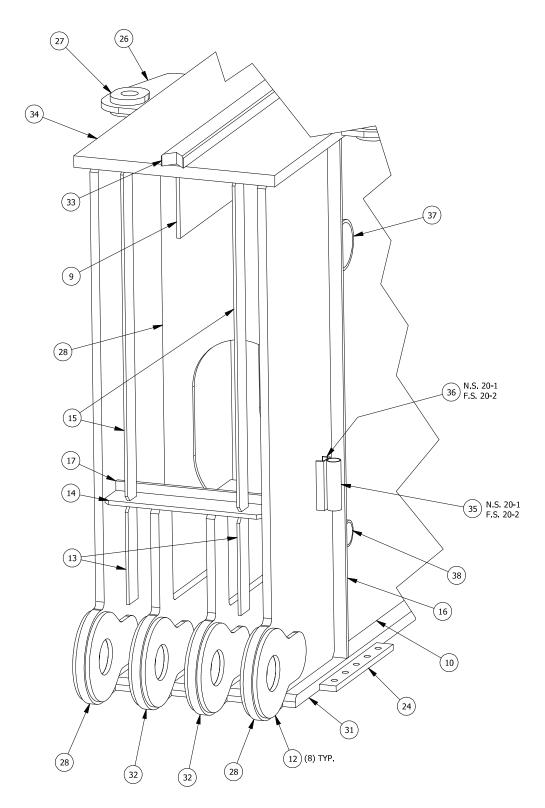
APPROX. FABRICATED WEIGHT: 25299 LBS.± APPROX, FINISHED WEIGHT: 25236 LBS.±
(2) REQUIRED AS SHOWN

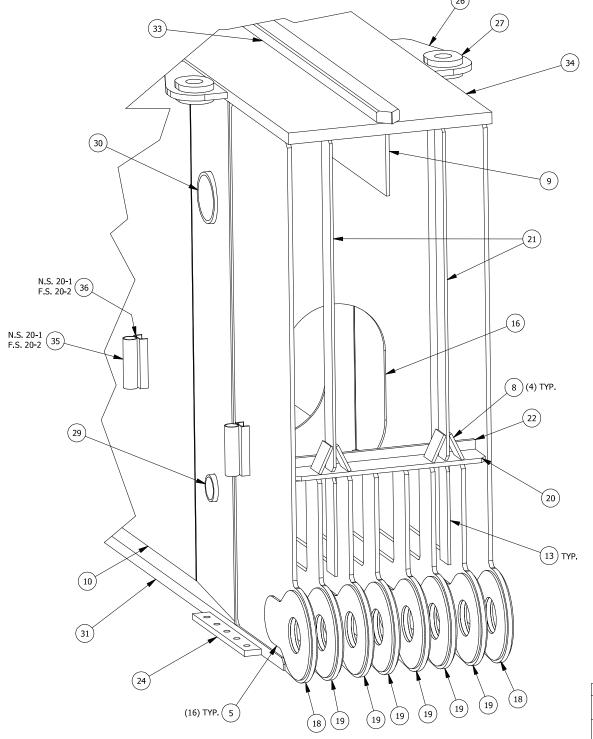
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TOLERANCES (U.N.O.)	NO.	NO. REVISIONS		DRAWN		ED .	APPROVED	
METRIC  X ±.5mm  XX ±.10mm  ±.01mm  ±.01mm  ±.01mm  ±.01s*  XX ±.00s*  XX ±.00s*  XX ±.000s*  Established 1974  This drawing contains information proprietary to Bigge Power Constructors. It is submitted in confidence and is to be used solely for the purpose for which it is furnished and returned upon request. This drawing and such information is not to be reproduced, transmitted, disclosed or used in whole or in part without the written authorization of Bigge Power Constructors.  **Introduction**  **Introductio							1	
ANGULAR: ± 0.25°	1 4	$\sim$ $         -$	VER CO	ONS	$\overline{TRUC}$	$\overline{TOF}$	$\overline{SS}$	

SME20 RECORD DRAWING **FABRICATION ISOMETRIC VIEWS** 20'-0" BOX GIRDER

HEAT TREATMENT:

ROCKWELL C ±4
BRINELL ±15 THIRD ANGLE PROJECTION  $\oplus$ + SCALE: (U.N.O) SIZE PROJECT No. SME20 1 of 19 0 В NTS





#### **4 LUG END ISOMETRIC DETAIL** NOTE: END PLATE (ITEM 25) HAS BEEN REMOVED FOR CLARITY

# **8 LUG END ISOMETRIC DETAIL**

NOTE: END PLATE (ITEM 25) HAS BEEN REMOVED FOR CLARITY

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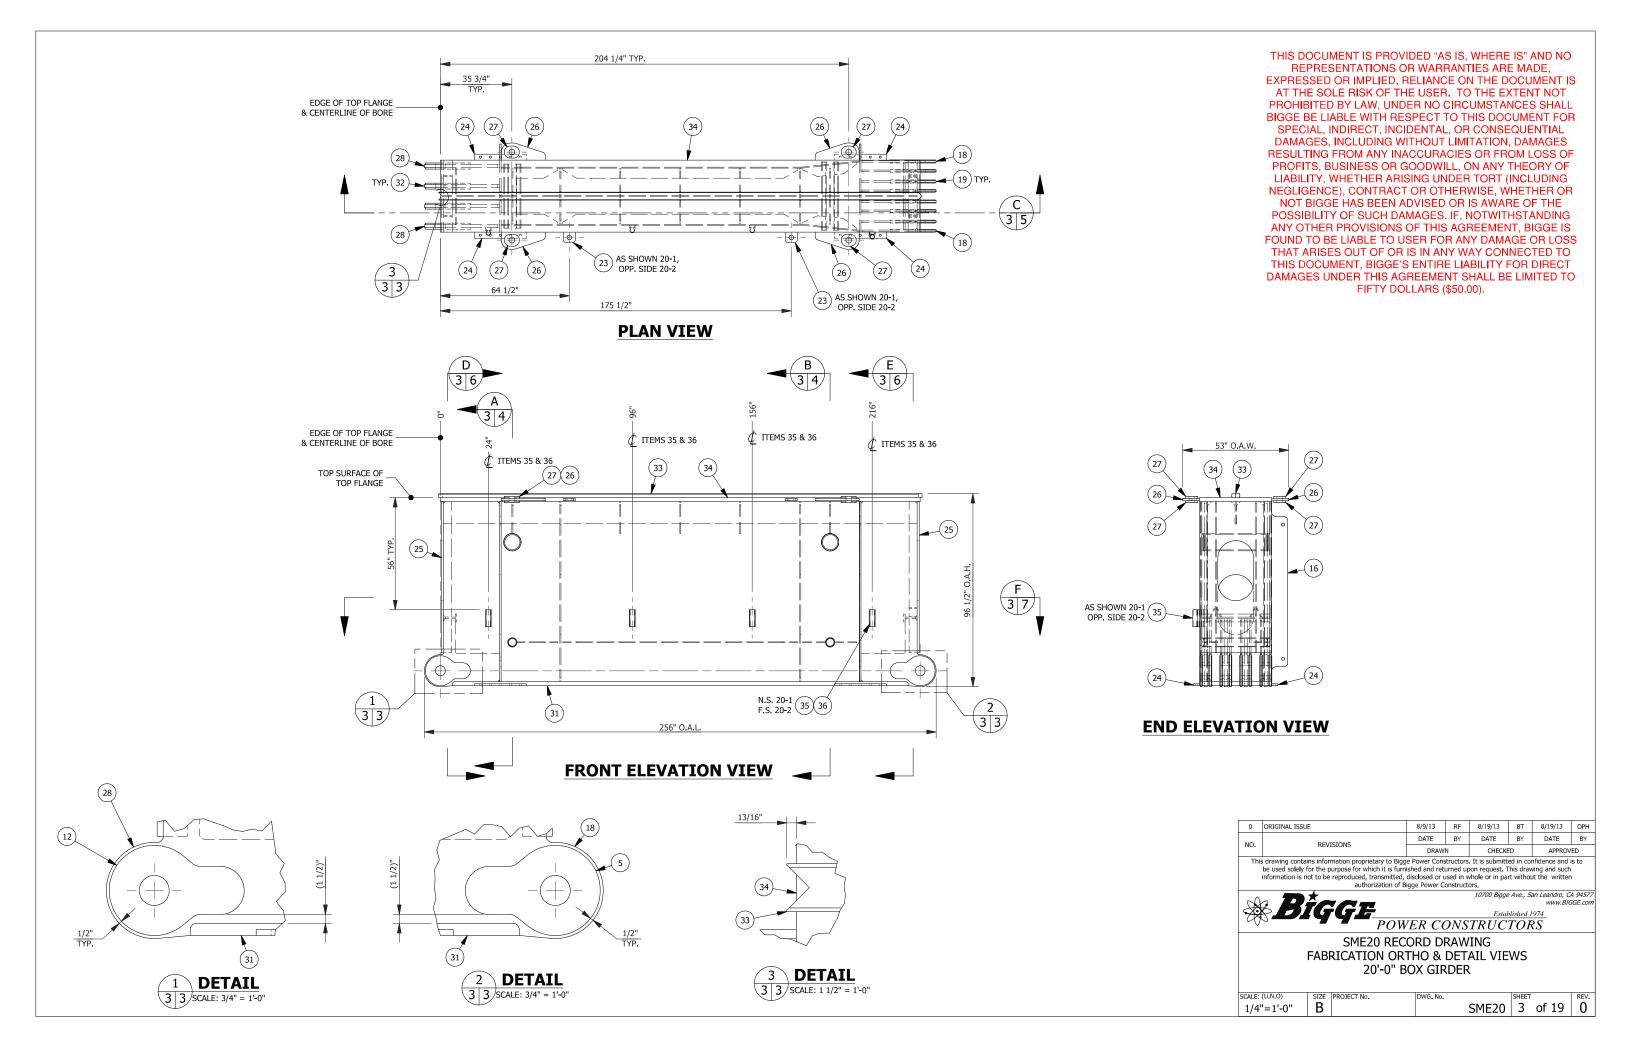
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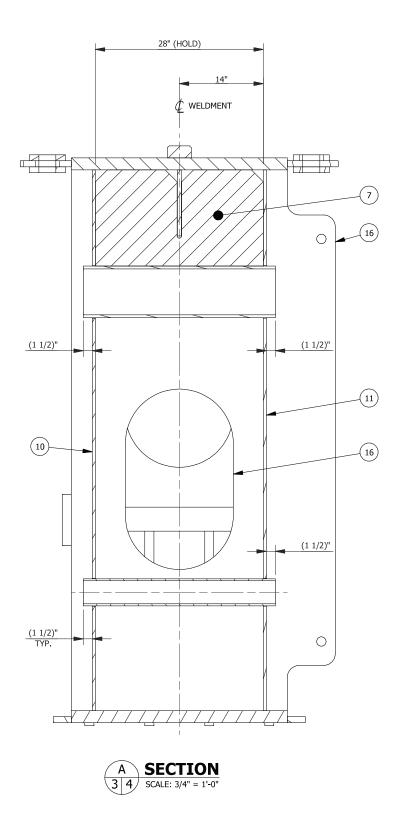
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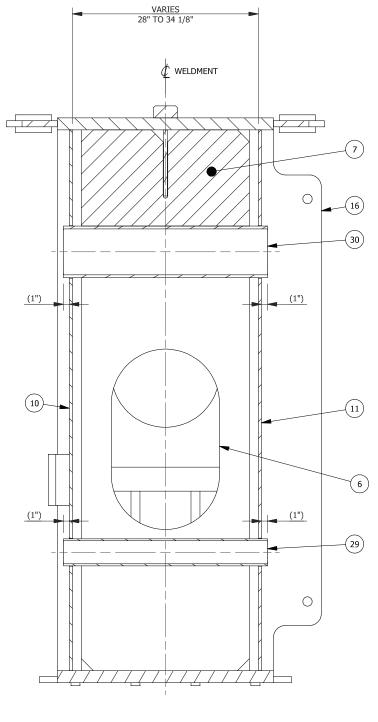


FABRICATION ISOMETRIC DETAIL VIEWS 20'-0" BOX GIRDER

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SCALE: (U.N.O)	SIZE	PROJECT No.	DWG. No.		SHEET		REV.	ı
NTS	В		SME2	0	2	of 19	0	









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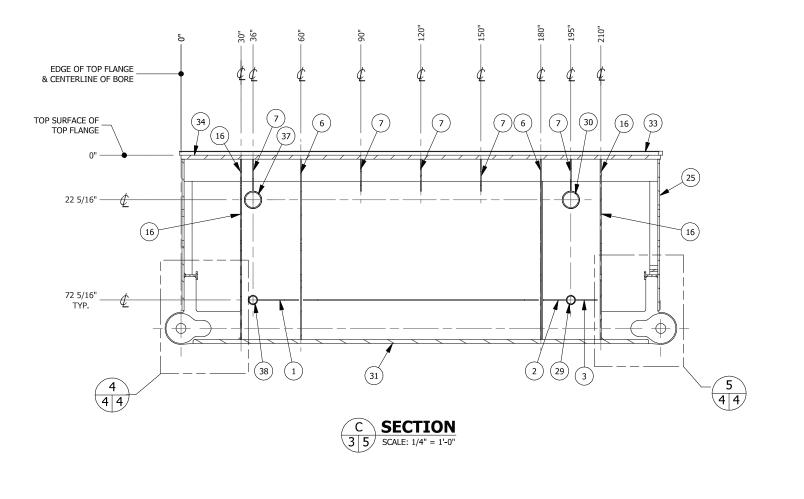
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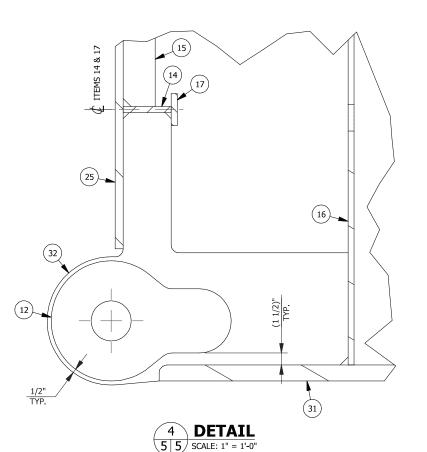
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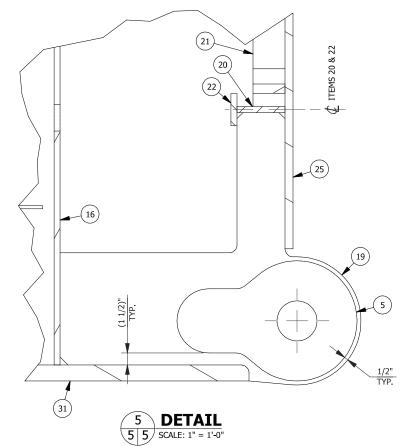


**FABRICATION SECTION VIEWS** 20'-0" BOX GIRDER

SCALE: (U.N.O)	SIZE	PROJECT No.	DWG. No.		SHEET		REV.
AS NOTED	В			SME20	4	of 19	0







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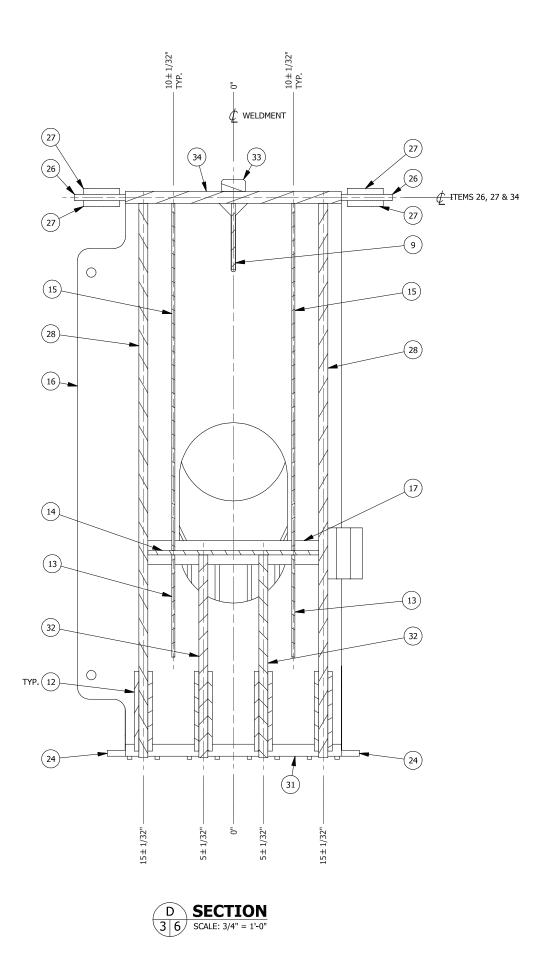
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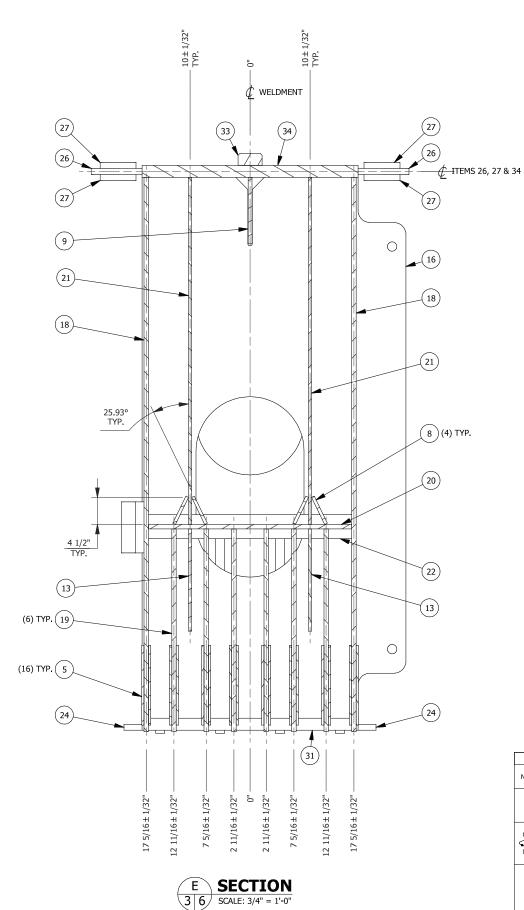
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SME20 RECORD DRAWING FABRICATION SECTION & DETAIL VIEWS 20'-0" BOX GIRDER

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SCALE: (U.N.O)	SIZE	PROJECT No.	DWG. No.	SHEET		REV.	l
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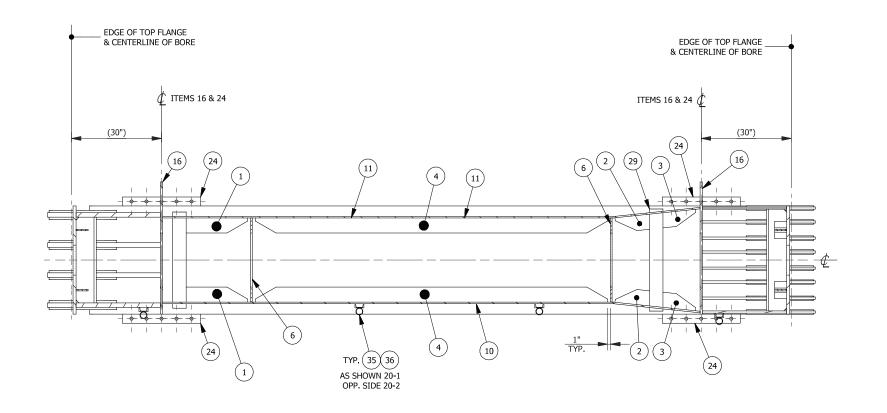
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20'-0" BOX GIRDER

SCALE: (U.N.O) SIZE PROJECT NO. DWG. NO. SME20 6 of 19 0





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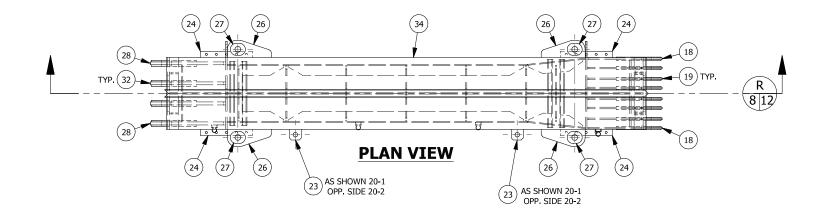
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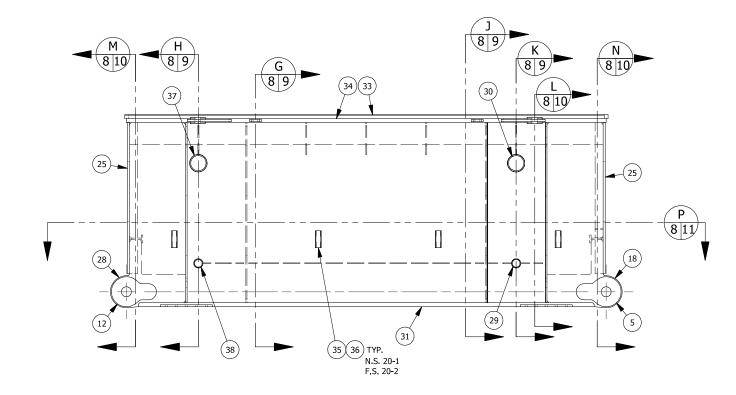
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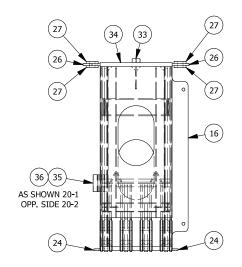


SME20 RECORD DRAWING FABRICATION SECTION VIEW 20'-0" BOX GIRDER

SCALE: (U.N.O)	SIZE	PROJECT No.	DWG. No.		SHEET		REV.	
AS NOTED	В		SI	ME20	7	of 19	0	







### FRONT ELEVATION VIEW

## **END ELEVATION VIEW**

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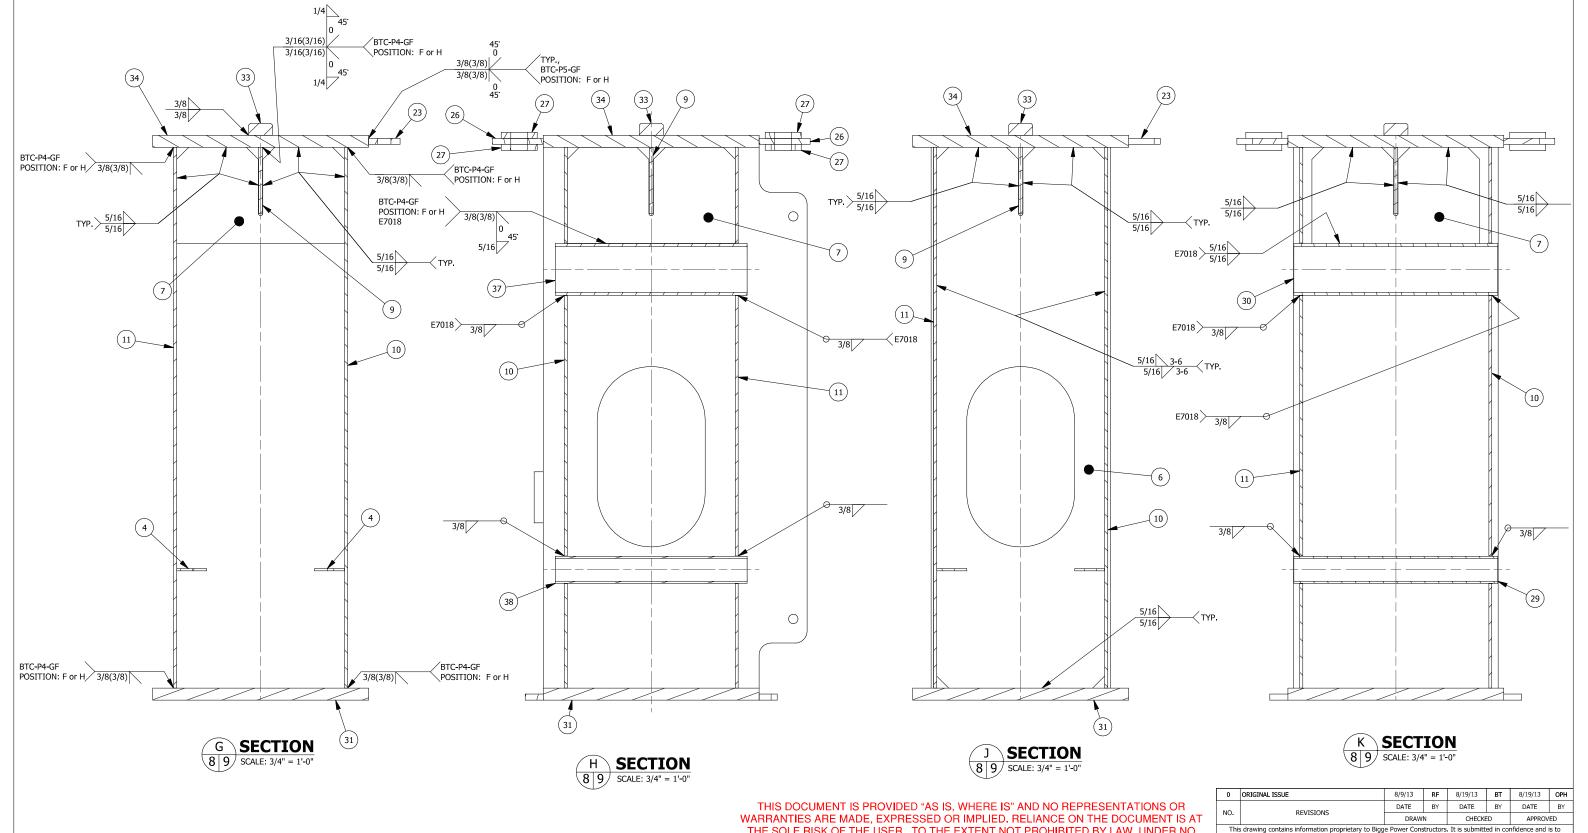
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SME20 RECORD DRAWING WELDING ORTHO VIEWS 20'-0" BOX GIRDER

1/4"=1'-0"	В		SME20	8	of 19	0	l
SCALE: (U.N.O)	SIZE	PROJECT No.	DWG. No.	SHEET		REV.	l



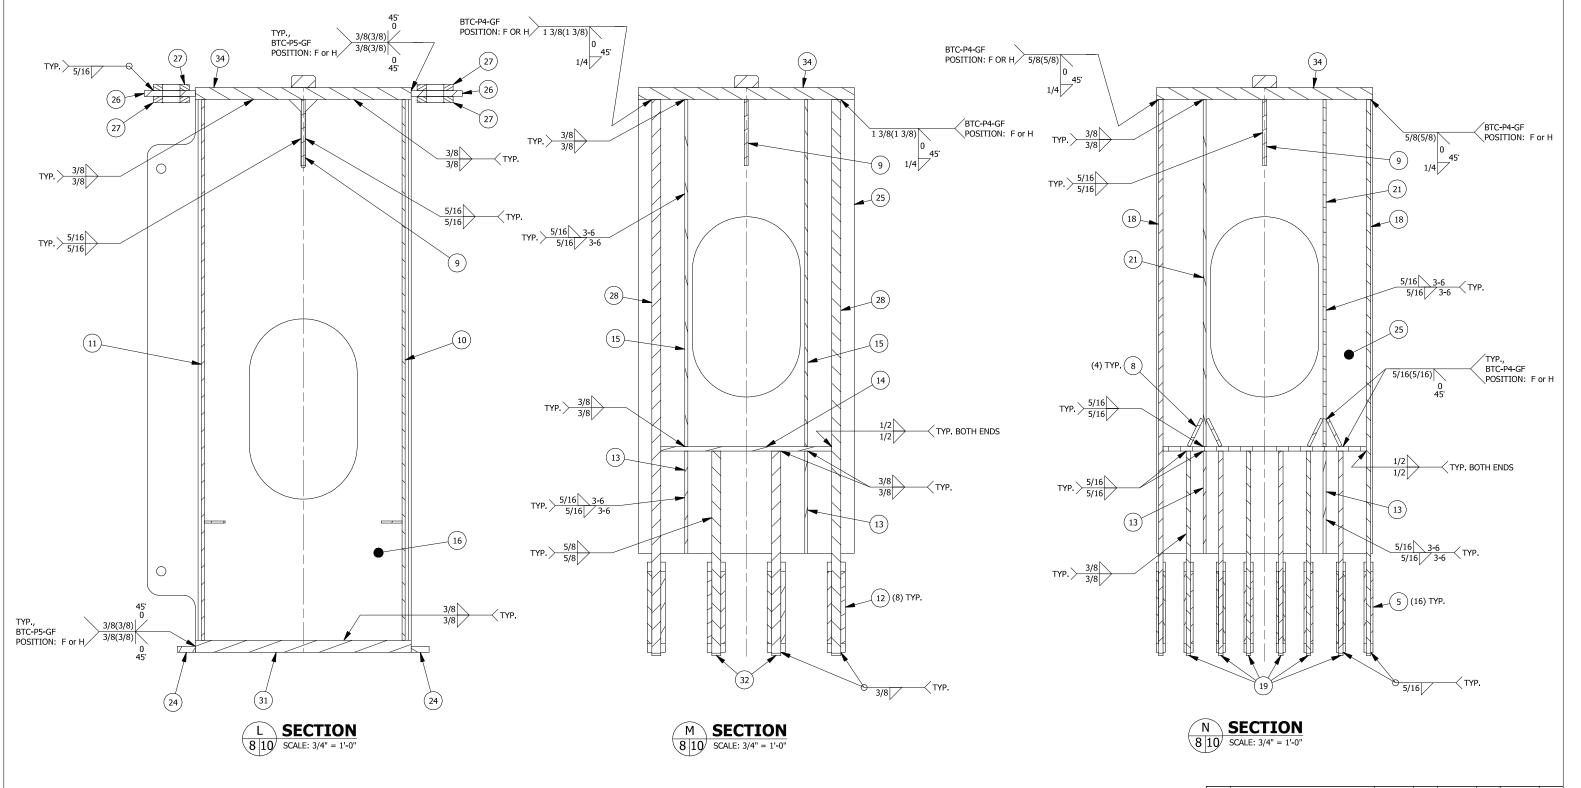
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WELDING SECTION VIEWS 20'-0" BOX GIRDER

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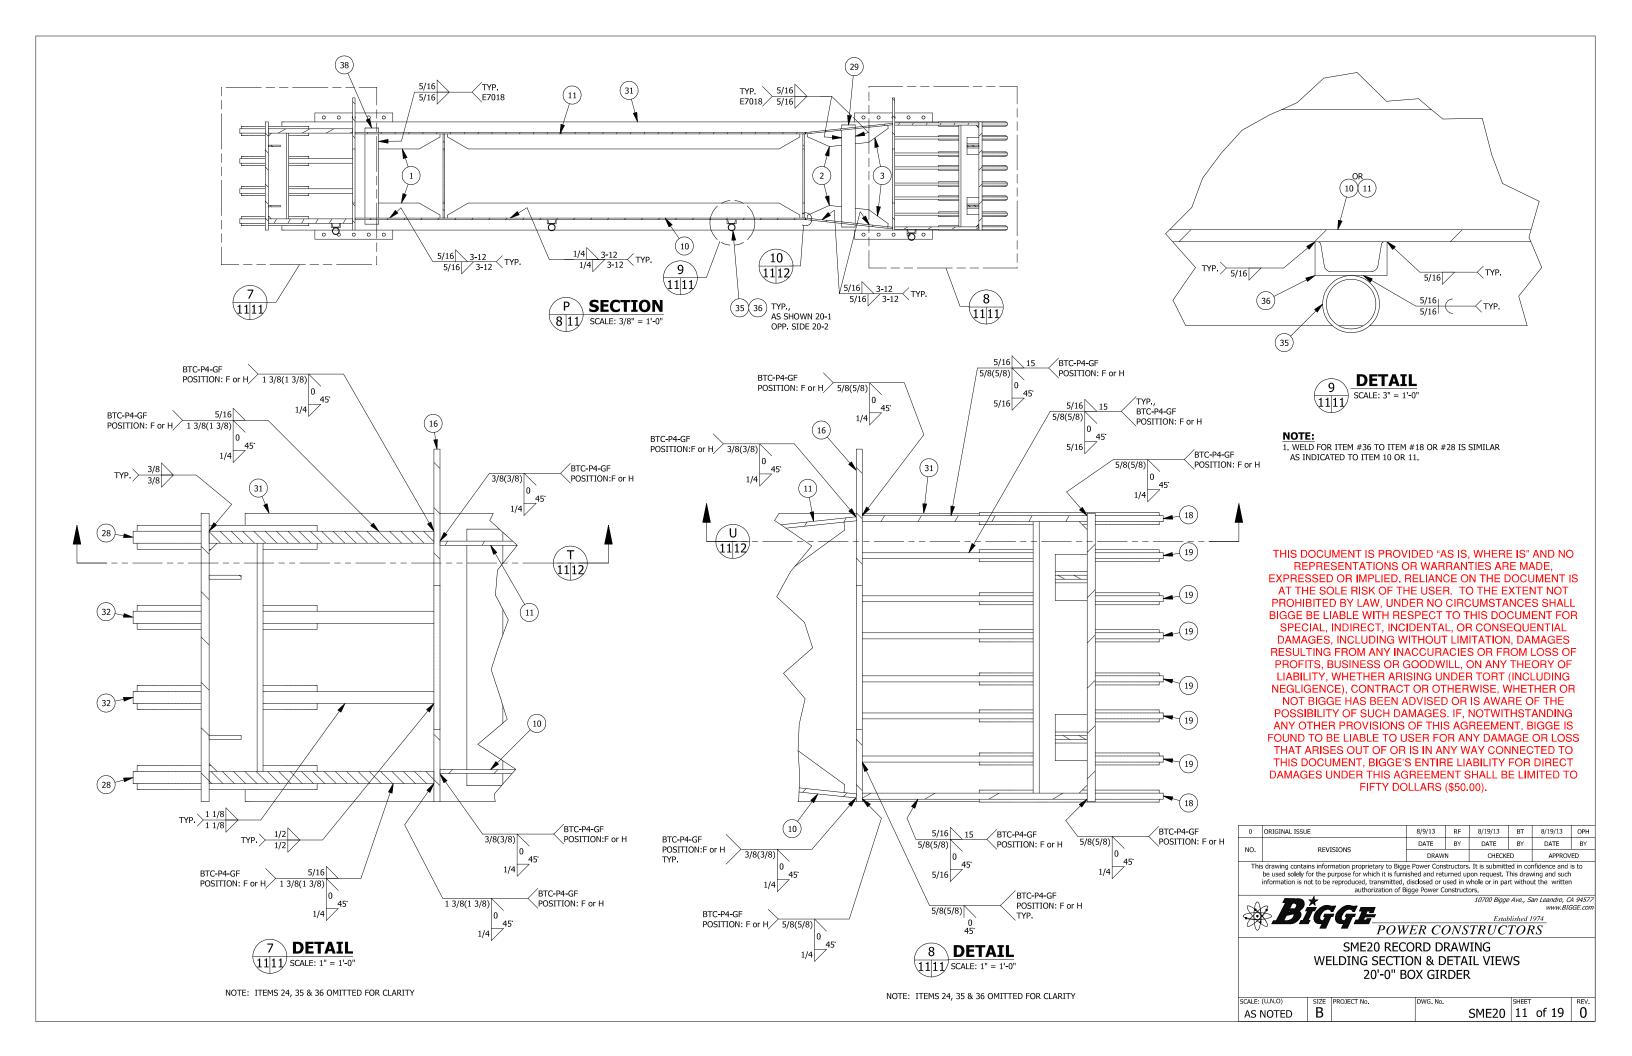
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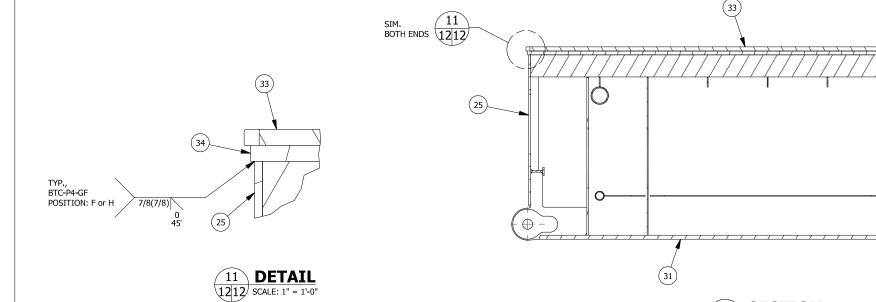
Established 1974

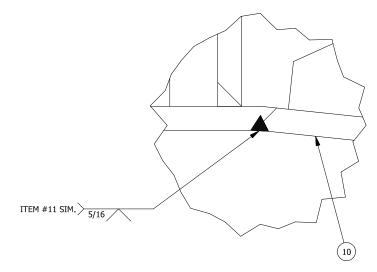
POWER CONSTRUCTORS

SME20 RECORD DRAWING WELDING SECTION VIEWS 20'-0" BOX GIRDER

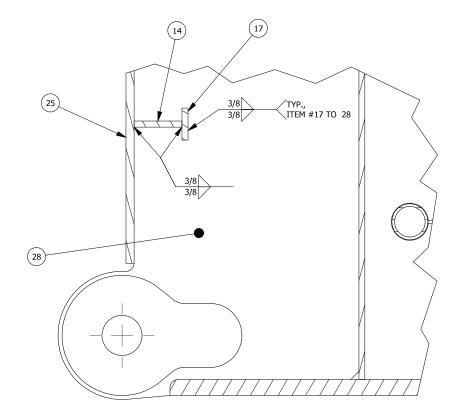
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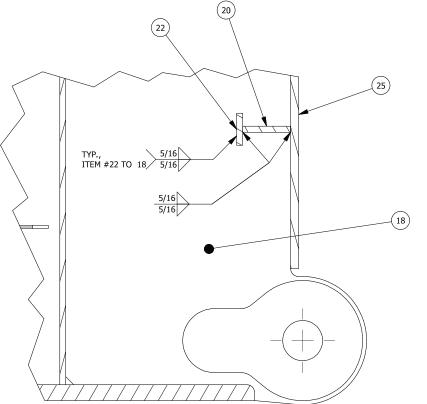






SECTION

1112 SCALE: 1" = 1'-0"



**2**5

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USECTION 1112 SCALE: 1" = 1'-0"

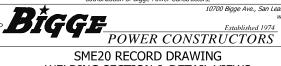
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DETAIL 10 1112

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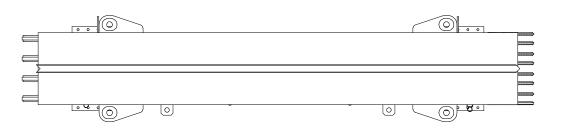
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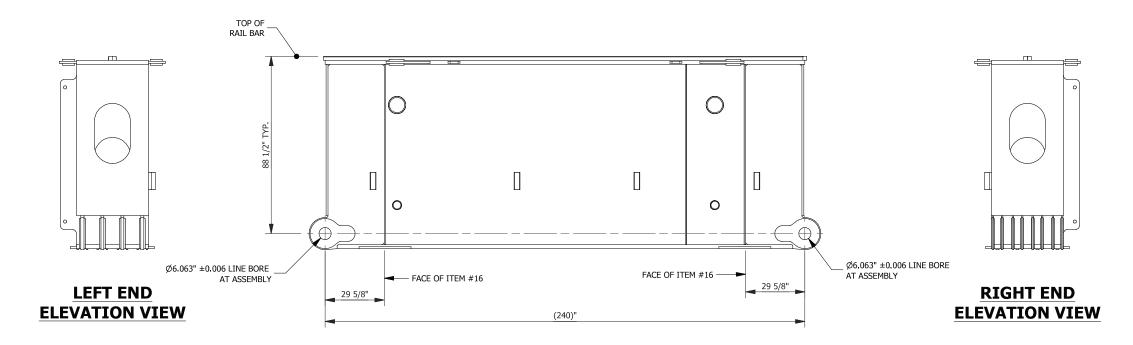


WELDING SECTION & DETAIL VIEWS 20'-0" BOX GIRDER

SCALE: (U.N.O)	SIZE	PROJECT No.	DWG. No.	SHEET	REV.
AS NOTED	В		SME20	12 of 19	0



#### **PLAN VIEW**



### **ELEVATION VIEW**

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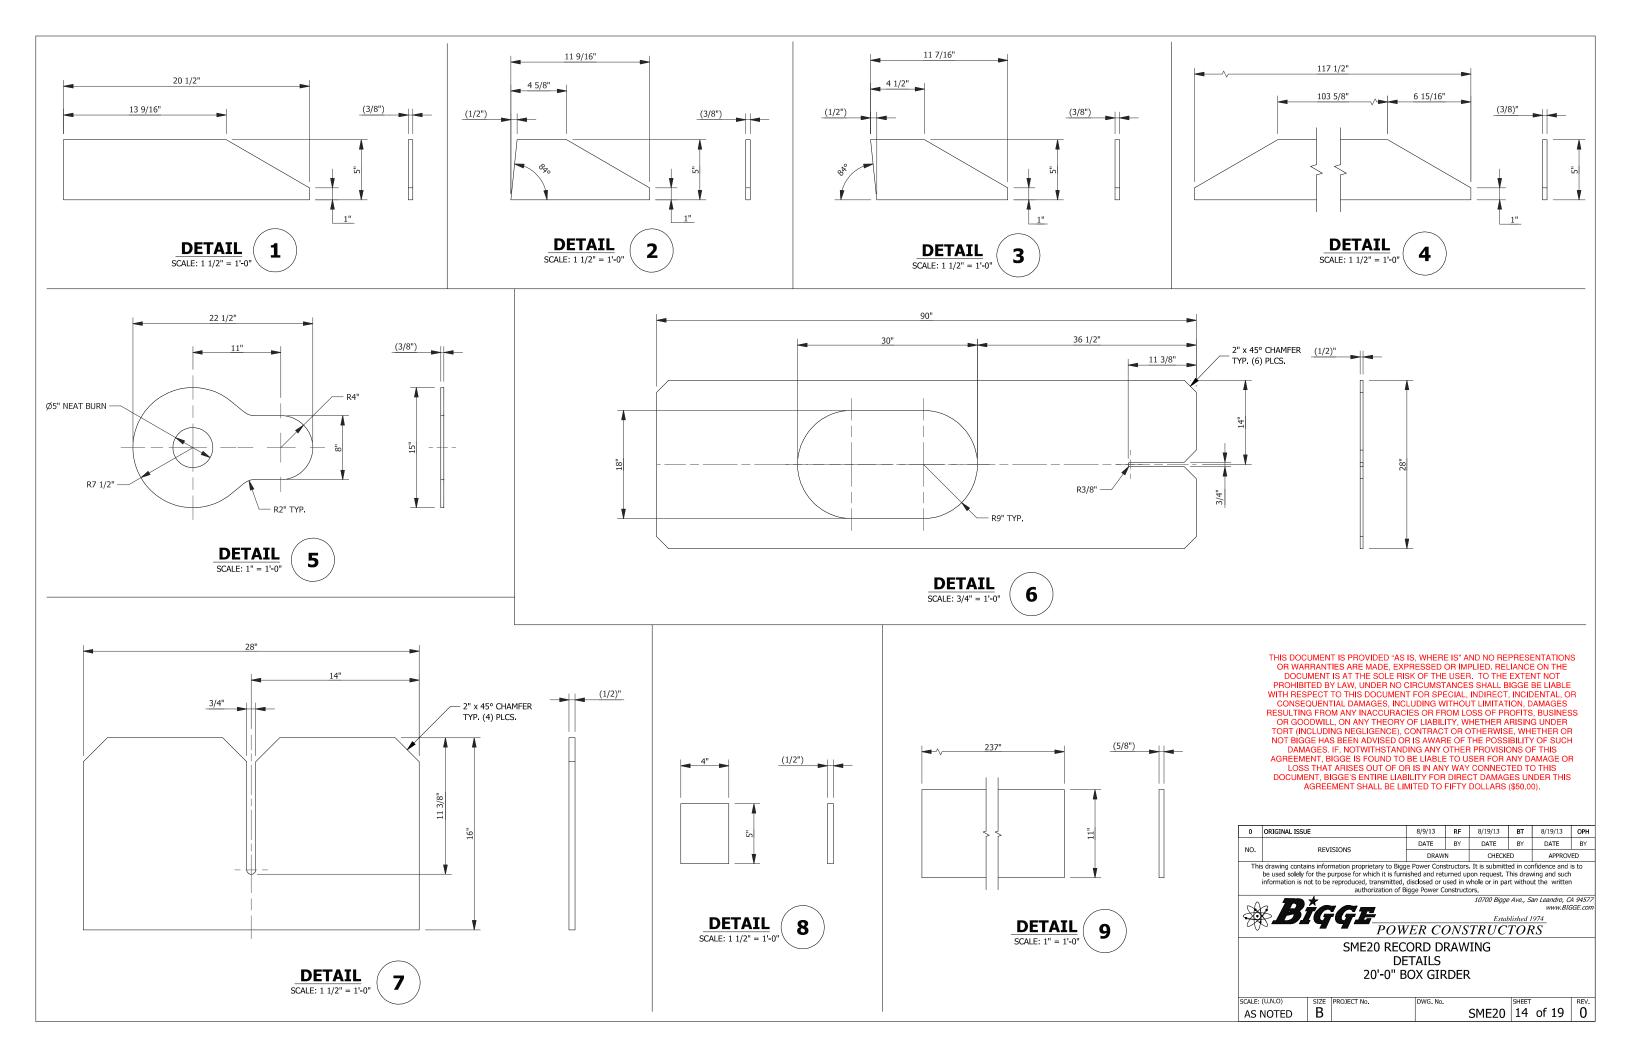
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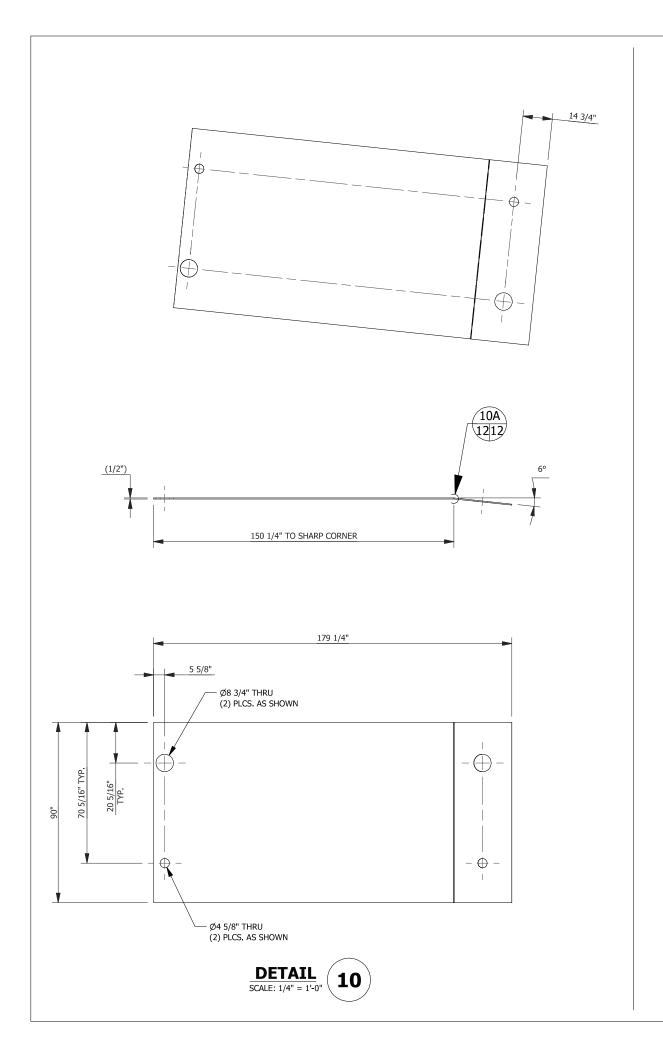
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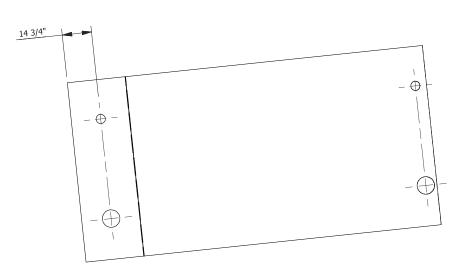
POWER CONSTRUCTORS

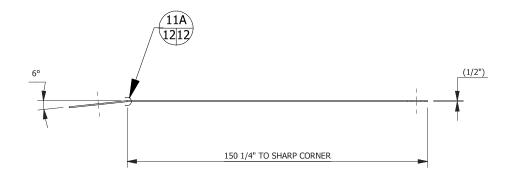
SME20 RECORD DRAWING MACHINING ORTHO VIEWS 20'-0" BOX GIRDER

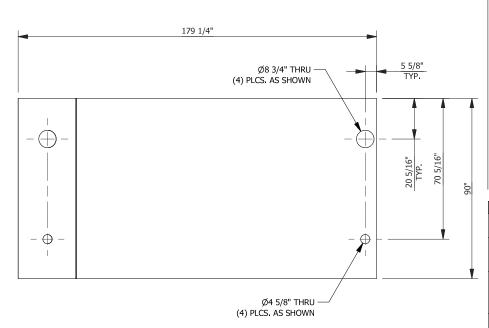
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1/4"=1'-0"	В		SME20	13	of 19	0	





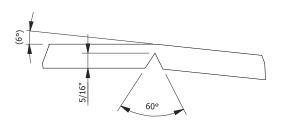




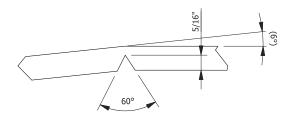


DETAIL
SCALE: 1/4" = 1'-0"

11









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NO.	REVISIONS	DRAWN		CHECKED		APPROVED	

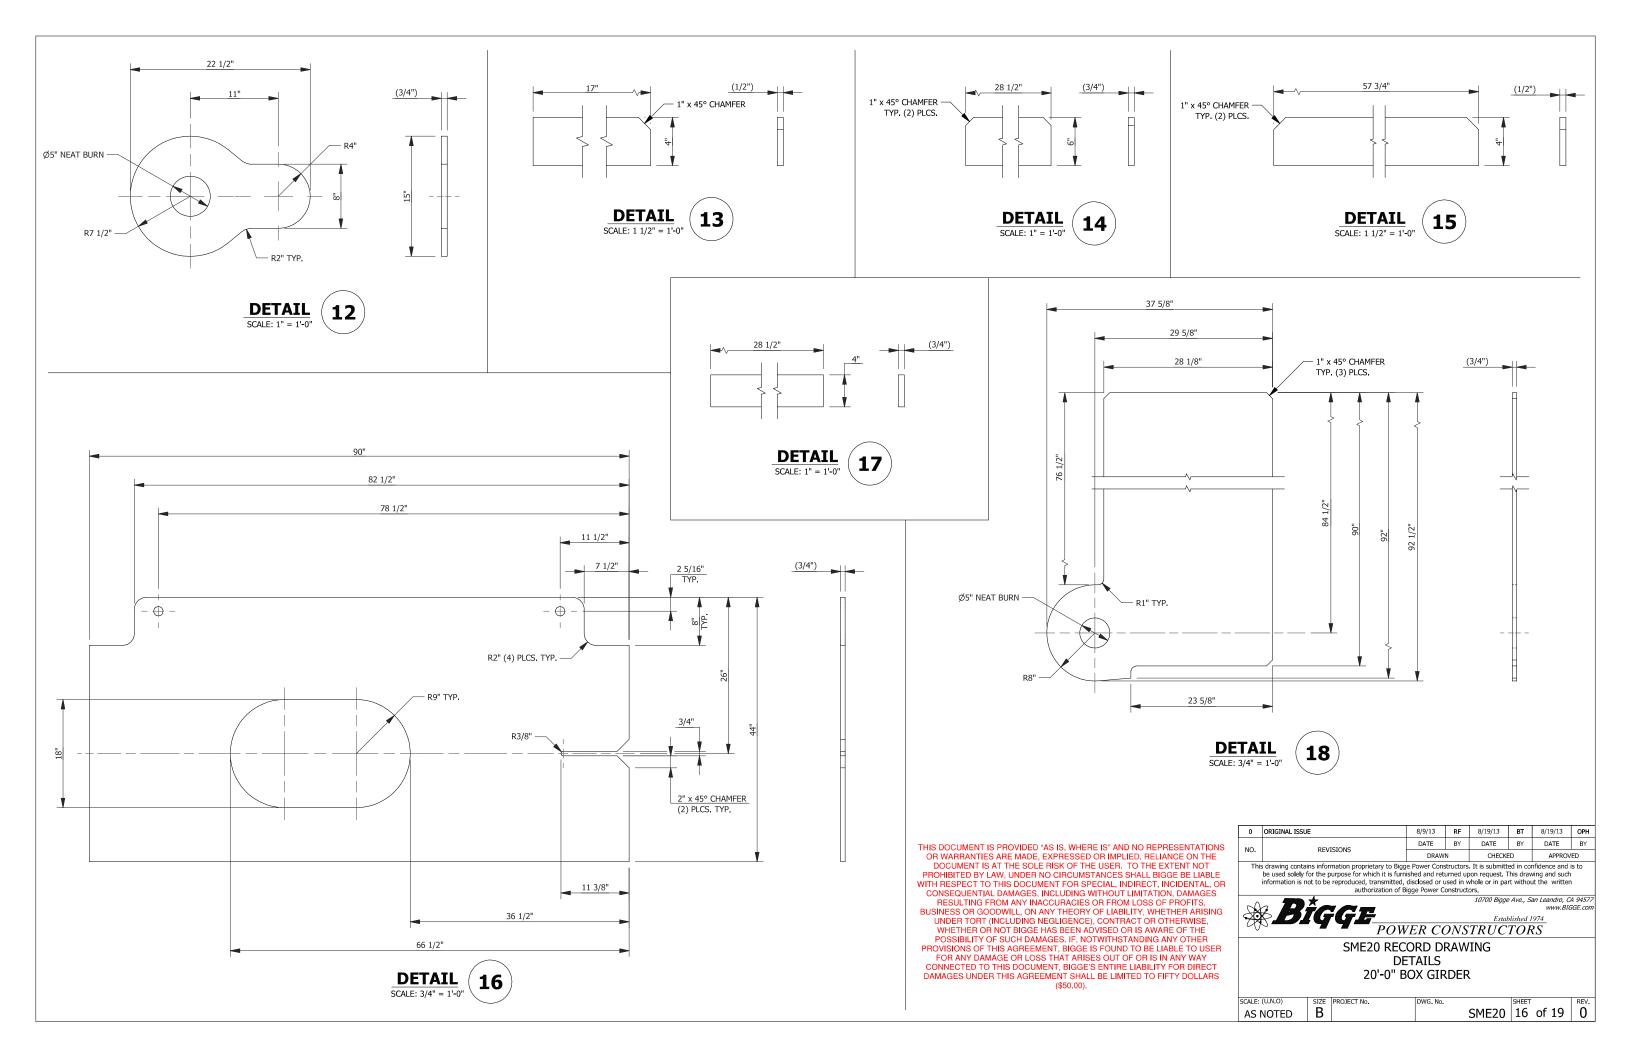
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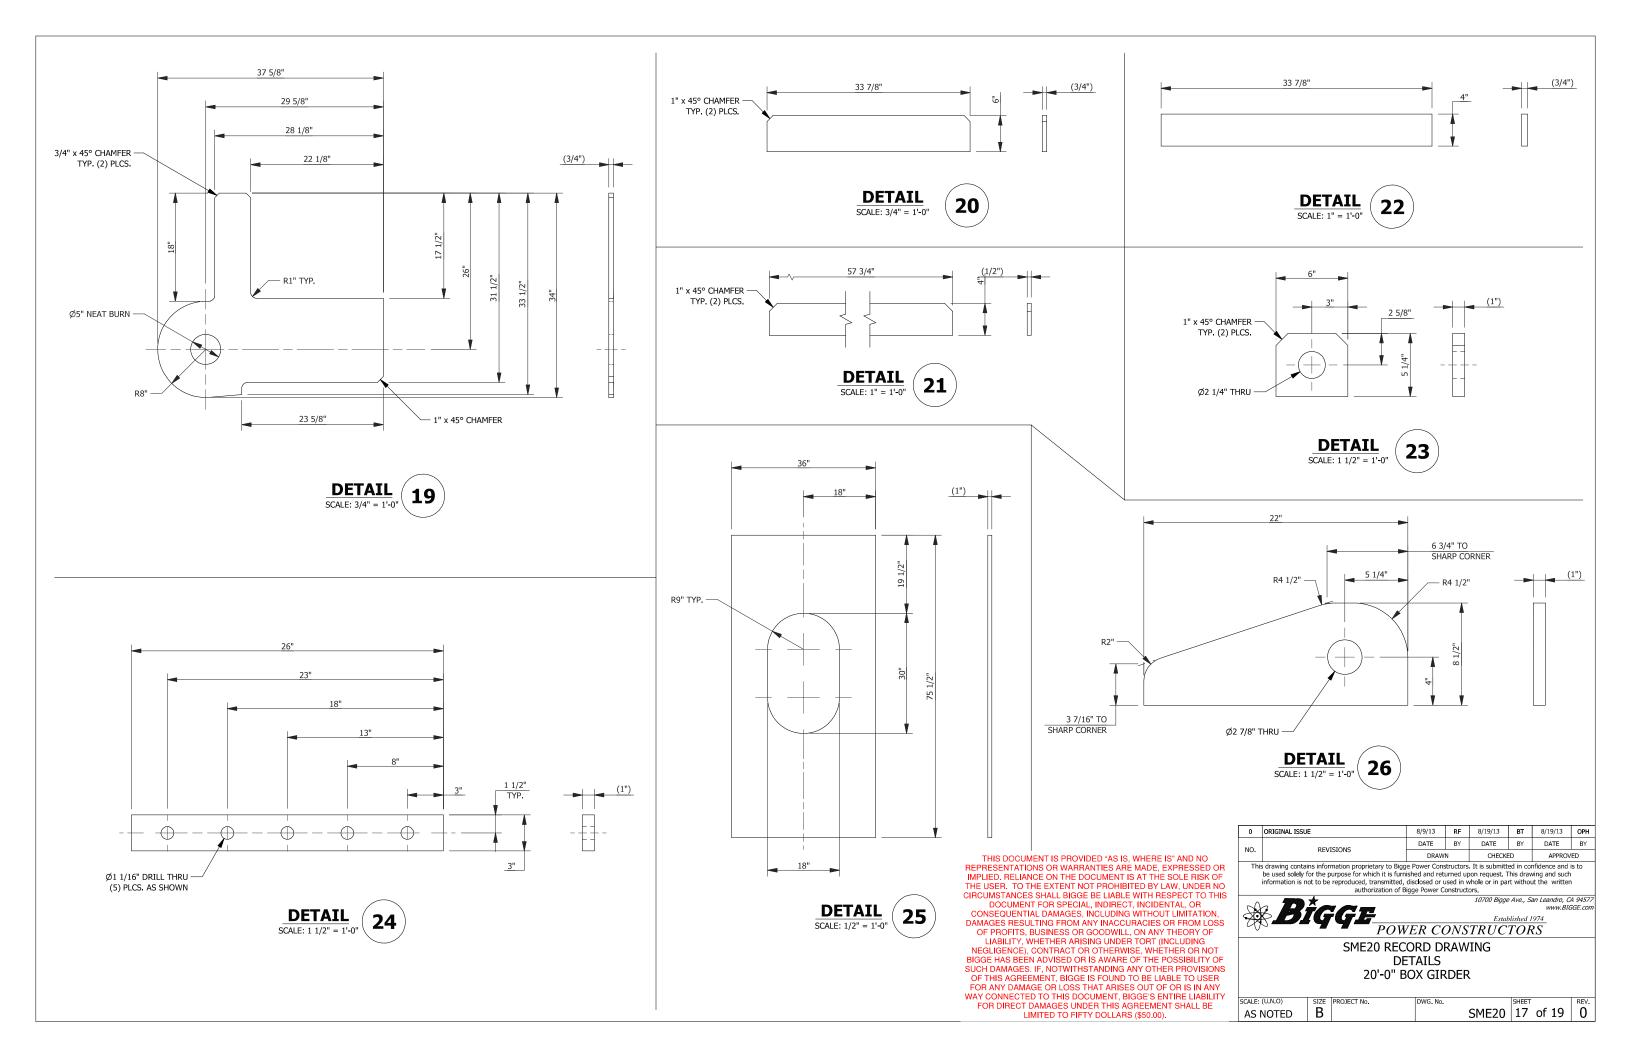
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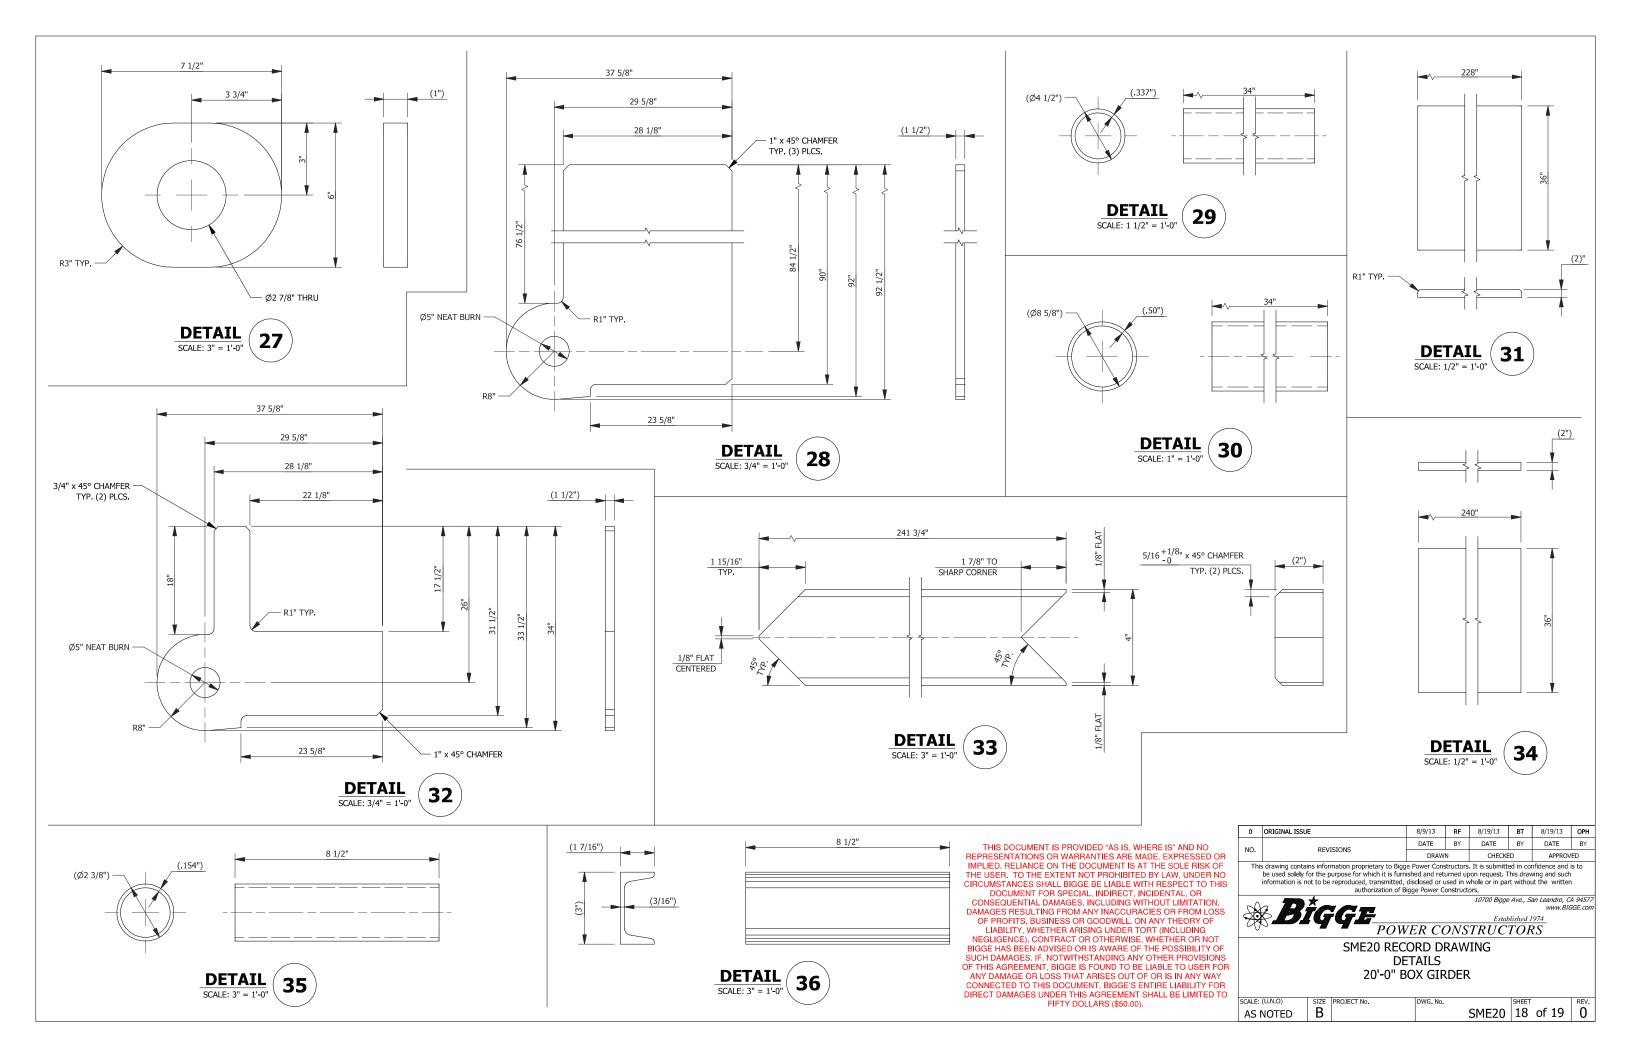


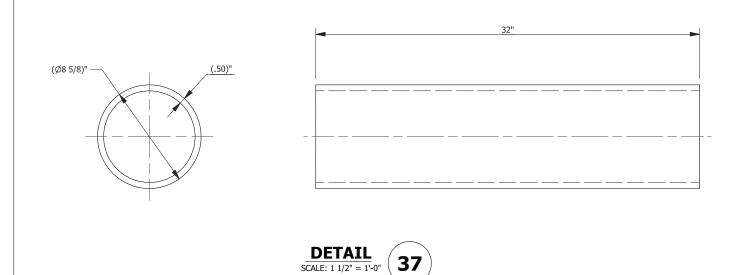
SME20 RECORD DRAWING DETAILS 20'-0" BOX GIRDER

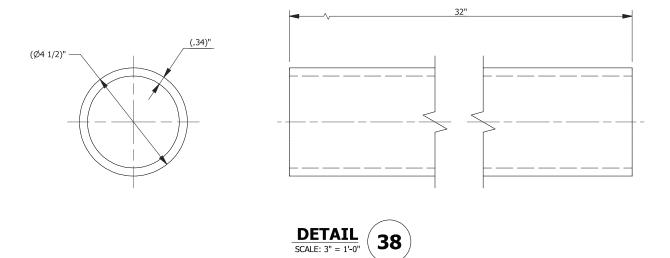
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SME20 RECORD DRAWING DETAILS 20'-0" BOX GIRDER

SCALE: (U.N.O)	SIZE	PROJECT No.	DWG. No.	SHEET		REV.
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